### LEGEND

### GENERAL NOTES:

#### A. GENERAL

1. ALL WORK TO BE CARRIED OUT TO CITY OF GREATER BENDIGO SPECIFICATIONS, STANDARD DRAWINGS AND TO THE SATISFACTION OF COUNCILS SENIOR SURVEILLANCE OFFICER OR HIS REPRESENTATIVE.

2. ALL LEVELS ARE TO AUSTRALIAN HEIGHT DATUM AND ALL COORDINATES ARE TO MAP GRID OF AUSTRALIA (MGA).

3. THE LOCATION OF EXISTING SERVICES SHOULD BE DETERMINED BY THE CONTRACTOR PRIOR TO COMMENCING ANY EXCAVATION BY CONTACTING ALL SERVICE AUTHORITIES. ANY EXISTING SERVICES SHOWN ON THESE DRAWINGS ARE OFFERED AS A GUIDE ONLY AND ARE NOT GUARANTEED AS CORRECT.

4. FILL AREAS ARE TO BE STRIPPED OF TOPSOIL, FILLED AND ONLY RE-TOPSOILED ON THE DIRECTION OF THE ENGINEER, TO THE FINAL FILL LEVELS SHOWN ON THE DRAWINGS. ALL FILLING IS TO BE:

APPROVED BY THE PROJECT GEOTECHNICAL CONSULTANT.PLACED IN LAYERS NOT EXCEEDING 200MM LOOSE THICKNESS.

- MOISTURE CONDITIONED TO WITHIN 85% TO 115% OF OPTIMUM MOISTURE CONTENT - COMPACTED TO A MINIMUM 95% (STANDARD) DRY DENSITY RATIO.

- PLACED UNDER "LEVEL 1" SUPERVISION IN ACCORDANCE WITH AS 3798-1996.

5. EXISTING DEPRESSIONS & DRAINS TRAVERSING THE SITE ARE TO BE CLEANED OUT AND DESLUDGED TO FIRM BASE AND FILLED TO FINISHED SURFACE LEVELS TO THE SPECIFIED COMPACTION STANDARDS.

6. TBM'S TO BE RE-ESTABLISHED BY THE LICENSED SURVEYOR IF FOUND TO BE MISSING AT THE COMMENCEMENT OF CONSTRUCTION. THE CONTRACTOR WILL BE RESPONSIBLE FOR CARE AND MAINTENANCE OF TBM'S THEREAFTER.

7. POSITION CONDUITS SO THAT A MINIMUM DISTANCE BETWEEN TAPPING IS 1.0M. CONDUITS TO BE LOCATED MIDWAY BETWEEN FENCE LINE OF LOT, UNLESS OTHERWISE SHOWN.

8. BEFORE COMMENCING WORK ON EXCAVATIONS IN EXCESS OF 1.5 M DEEP, THE REQUIRED NOTICE IS TO BE SENT TO THE VICTORIAN WORKCOVER AUTHORITY IN ACCORDANCE WITH THE MINES ACT, 1958 NO 6320 SECTION 385 AND THE OCCUPATIONAL HEALTH AND SAFETY ACT 1985. THIS NOTIFICATION MUST BE RECEIVED BY THE AUTHORITY AT LEAST 3 DAYS PRIOR TO COMMENCING EXCAVATIONS, AND A COPY OF THE NOTIFICATION MUST BE PROVIDED TO THE SUPERINTENDENT.

9. COUNCIL'S REPRESENTATIVE IS TO BE NOTIFIED IN WRITING SEVEN (7) DAYS PRIOR TO THE COMMENCEMENT OF WORKS.

10. NO EXCAVATION WITHIN 5M OF ANY EXISTING TREE WITHOUT APPROVAL OF THE ENGINEER.

11. NO BLASTING IS PERMITTED WITHIN THE CITY OF GREATER BENDIGO WITHOUT OBTAINING COUNCIL'S SPECIAL DISPENSATION.

12. EXCAVATED MATERIAL SURPLUS TO FILLING REQUIREMENTS OF THE WORKS SHALL BE REMOVED FROM SITE AS SPECIFIED.

13. ALL SURPLUS ROCK, CONCRETE AND BITUMINOUS RUBBLE SHALL BE DISPOSED OFF SITE AS SPECIFIED. THE CONTRACTOR SHALL CHECK WITH SUPERINTENDENT WHETHER ANY LARGE ROCKS ARE REQUIRED FOR LANDSCAPE PURPOSES PRIOR TO DISPOSAL.

14. NATURESTRIPS AND ALL AREAS OF CUT OUTSIDE ROAD RESERVE TO BE SURFACED WITH 100MM MINIMUM COMPACTED LAYER OF

### B. ROAD WORKS

1. FOOTPATHS ARE TO BE 1.5M WIDE UNLESS SHOWN OTHERWISE. FOOTPATHS TO BE CONSTRUCTED TO THE CITY OF GREATER BENDIGO STANDARDS.

2. CONSTRUCT LAYBACK SECTION AT VEHICLE CROSSING, REVERSING BAYS AND CAR PARKING BAYS AND PRAM CROSSING TO THE CITY OF GREATER BENDIGO STANDARDS.

3. ALL CHAINAGES REFER TO ROAD PAVEMENT CENTRELINES EXCEPT IN COURT HEADS AND INTERSECTIONS WHERE CHAINAGES REFER TO BACK OF KERB.

4. THE CONTRACTOR IS REQUIRED TO CONFINE CONSTRUCTION VEHICLES TO THE ROAD RESERVE AND EASEMENTS. ANY DAMAGE CAUSED TO ALLOTMENTS MUST BE MADE GOOD.

5. ALL BATTERS SHALL BE TO THE CITY OF GREATER BENDIGO STANDARDS.

- CUT 1 IN 12 UNLESS OTHERWISE SHOWN

- CUT 1 IN 12 UNLESS OTHERWISE SHOWN. - FILL 1 IN 12 UNLESS OTHERWISE SHOWN.


6. ALL SET OUT INFORMATION GIVEN IS TO BACK OF KERB UNLESS OTHERWISE SHOWN.

7. WHERE CRUSHED ROCK IS SHOWN UNDER CONCRETE FOOTPATHS CONSTRUCTED ON FILL, THE CRUSHED ROCK IS TO BE 20MM CLASS 3. WHERE CUT BATTERS ARE STEEPER THAN 1:6 THEY MUST BE HYDRO MULCHED.


8. SUBGRADE BE COMPACTED TO A MINIMUM OF 98% STANDARD MAXIMUM DRY DENSITY (AS3798), WITH THE SUBBASE COMPACTED IN ACCORDANCE WITH SCALE C INVICROADS TABLE 304.071 USING FINE CRUSHED ROCK AND THE BASE COURSE TO AN AVERAGE OF 100% MINIMUM MODIFIED DRY DENSITY. ANY FILLING BENEATH ROAD PAVEMENT AREAS TO BE COMPACTED TO 100% OF MAXIMUM DRY DENSITY.COMPACTION TESTING TO BE AS PER COUNCIL REQUIREMENTS.

9. ANY BACKFILL WITHIN 1.0M OF A COUNCIL ASSET (FOOTPATH OR ROAD) IS TO BE FCR. FILL MATERIAL IS ACCEPTABLE IF COMPACTED TO ENSURE 95% COMPACTION. COMPACTION TESTING TO BE PERFORMED AT ONE PER 60M OF TRENCH.

10. CONCRETE TO HAVE 28DAY STRENGTH OF 25MPA UNLESS NOTED OTHERWISE

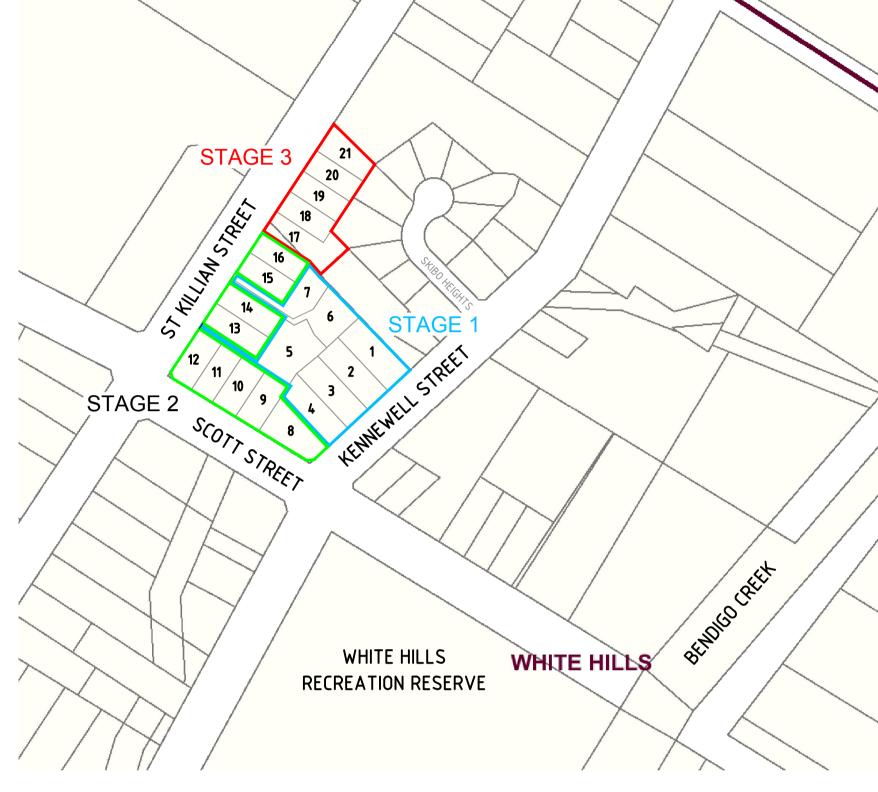

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# SERVICE LOCATION TABLE

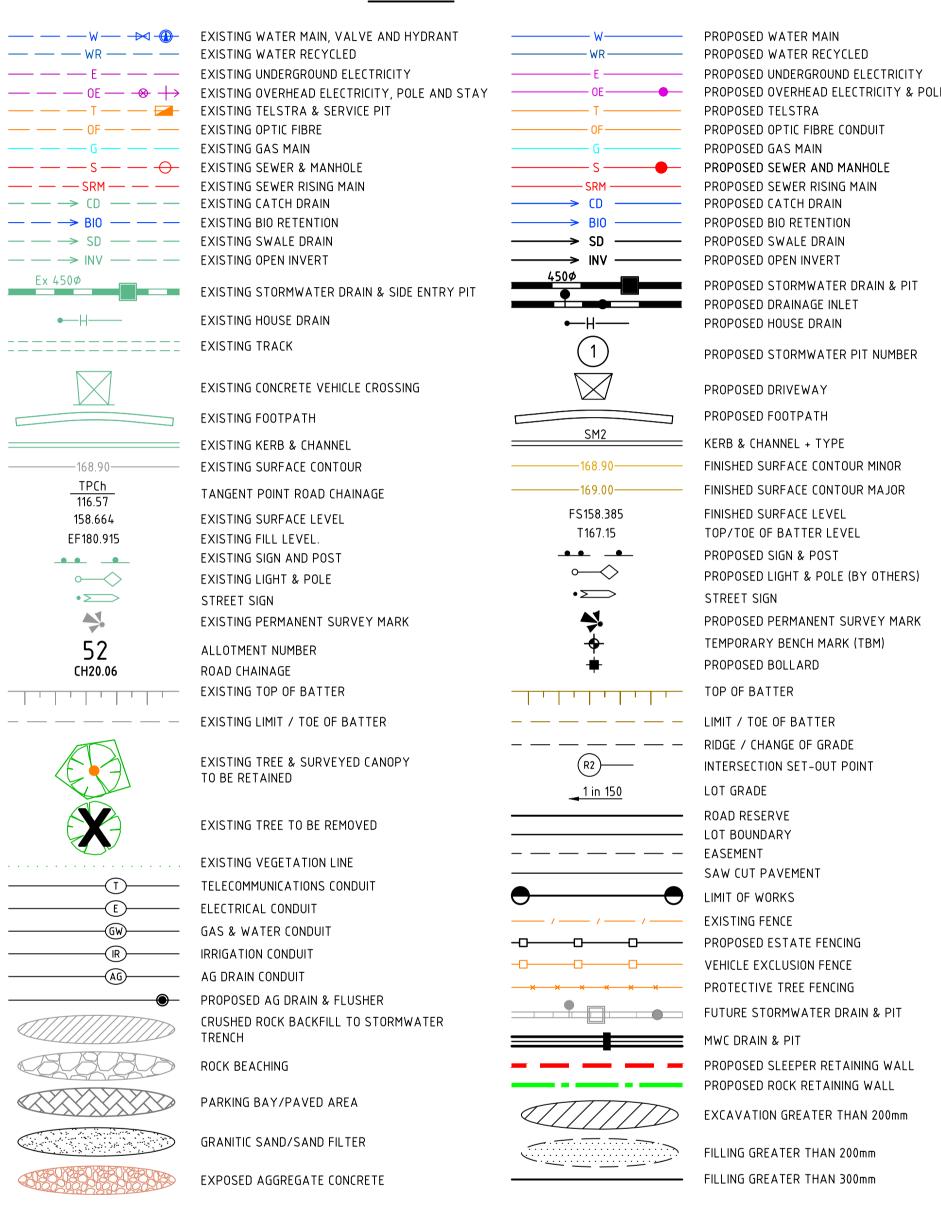ROAD NAME		POTABLE WATER		AS		BN ECOM)	ELECTRICITY				
	SIDE	OFFSET	SIDE	OFFSET	SIDE	OFFCET	POLE		U/G CABLE		
	SIDE			UFFSET	SIDE	OFFSET	SIDE	OFFSET	SIDE	OFFSET	
KENNEWELL STREET	W	3.4 (EX)	E	4.0 (EX)	W	1.5 (EX)	Е	3.0 (EX)	Е	4.5	
SCOTT STREET	N	5.0 (EX)	N	3.6 (EX)	N	2.6 (EX)	-	-	-	-	
ST KILLIAN STREET (CH 50.00 - 100.00)	E	3.9 (Var)	Е	4.4 (Var)	Е	2.7	W	4.0 (EX)	E	2.2	
ST KILLIAN STREET (CH 130.00 - 180.00)	F	2.5 (Var)	F	3 ( (Var)	F	1.75 (FX)	W	4.0 (FX)	F	1.0	

1. TELECOMMUNICATIONS AND ELECTRICITY CABLES TO BE CONSTRUCTED IN A COMMON TRENCH IN ACCORDANCE WITH ELECTRICITY

AUTHORITY STANDARD DRG's.

GAS AND WATER MAINS TO BE CONSTRUCTED IN A COMMON TRENCH.

× = OFFSET FROM BACK OF KERB

4. (EX) = SERVICE IS EXISTING
 5. (Var) = SERVICE OFFSET CAN VARY IN SECTIONS

WARNING
BEWARE OF UNDERGROUND/OVERHEAD SERVICES
THE LOCATION OF SERVICES ARE APPROXIMATE ONLY
AND THEIR EXACT POSITION SHOULD BE PROVEN ON
SITE. NO GUARANTEE IS GIVEN THAT ALL EXISTING
SERVICES ARE SHOWN.SPECIAL CONSIDERATION
SHOULD BE GIVEN TO CONSTRUCTION PROCEDURES
UNDER OVERHEAD ELECTRICITY TRANSMISSION LINES.



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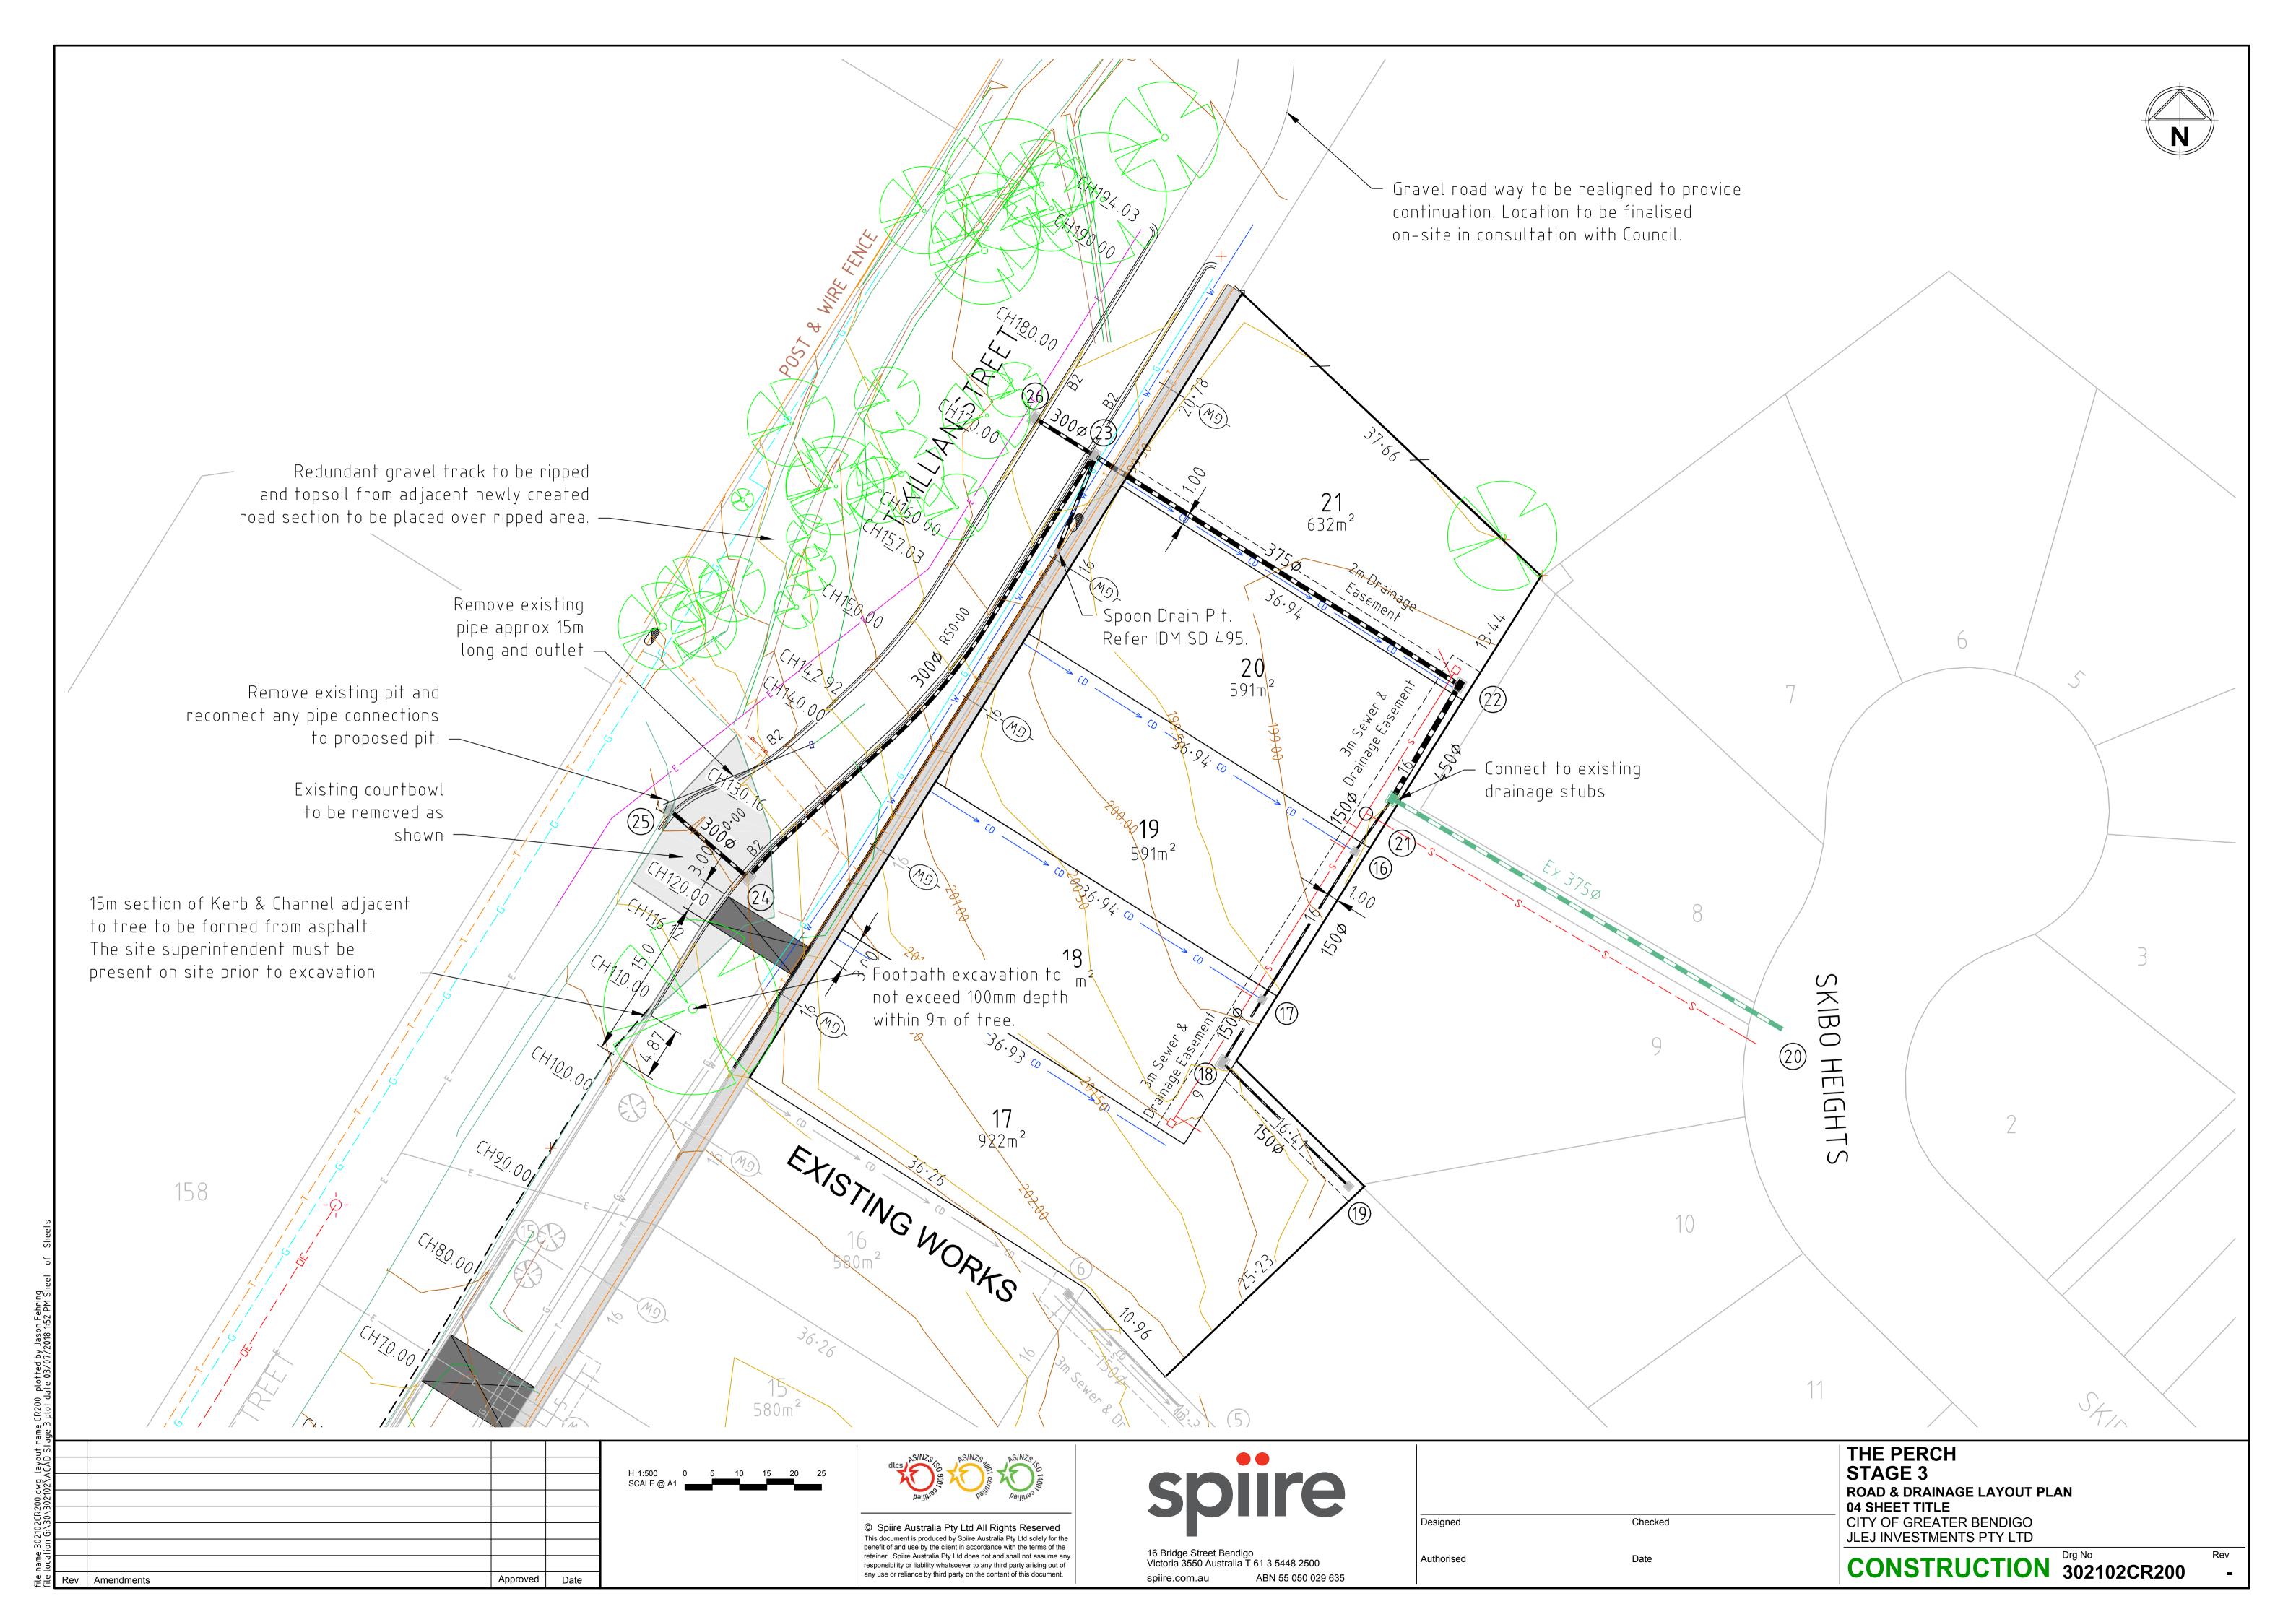
16 Bridge Street Bendigo
Victoria 3550 Australia T 61 3 5448 2500
spiire.com.au ABN 55 050 029 635


Designed	Checked	
Authorised	Date	

THE PERCH
STAGE 3
ROAD & DRAINAGE FACE SHEET

CITY OF GREATER BENDIGO
JLEJ INVESTMENTS PTY LTD

CONSTRUCTION 302102CR100



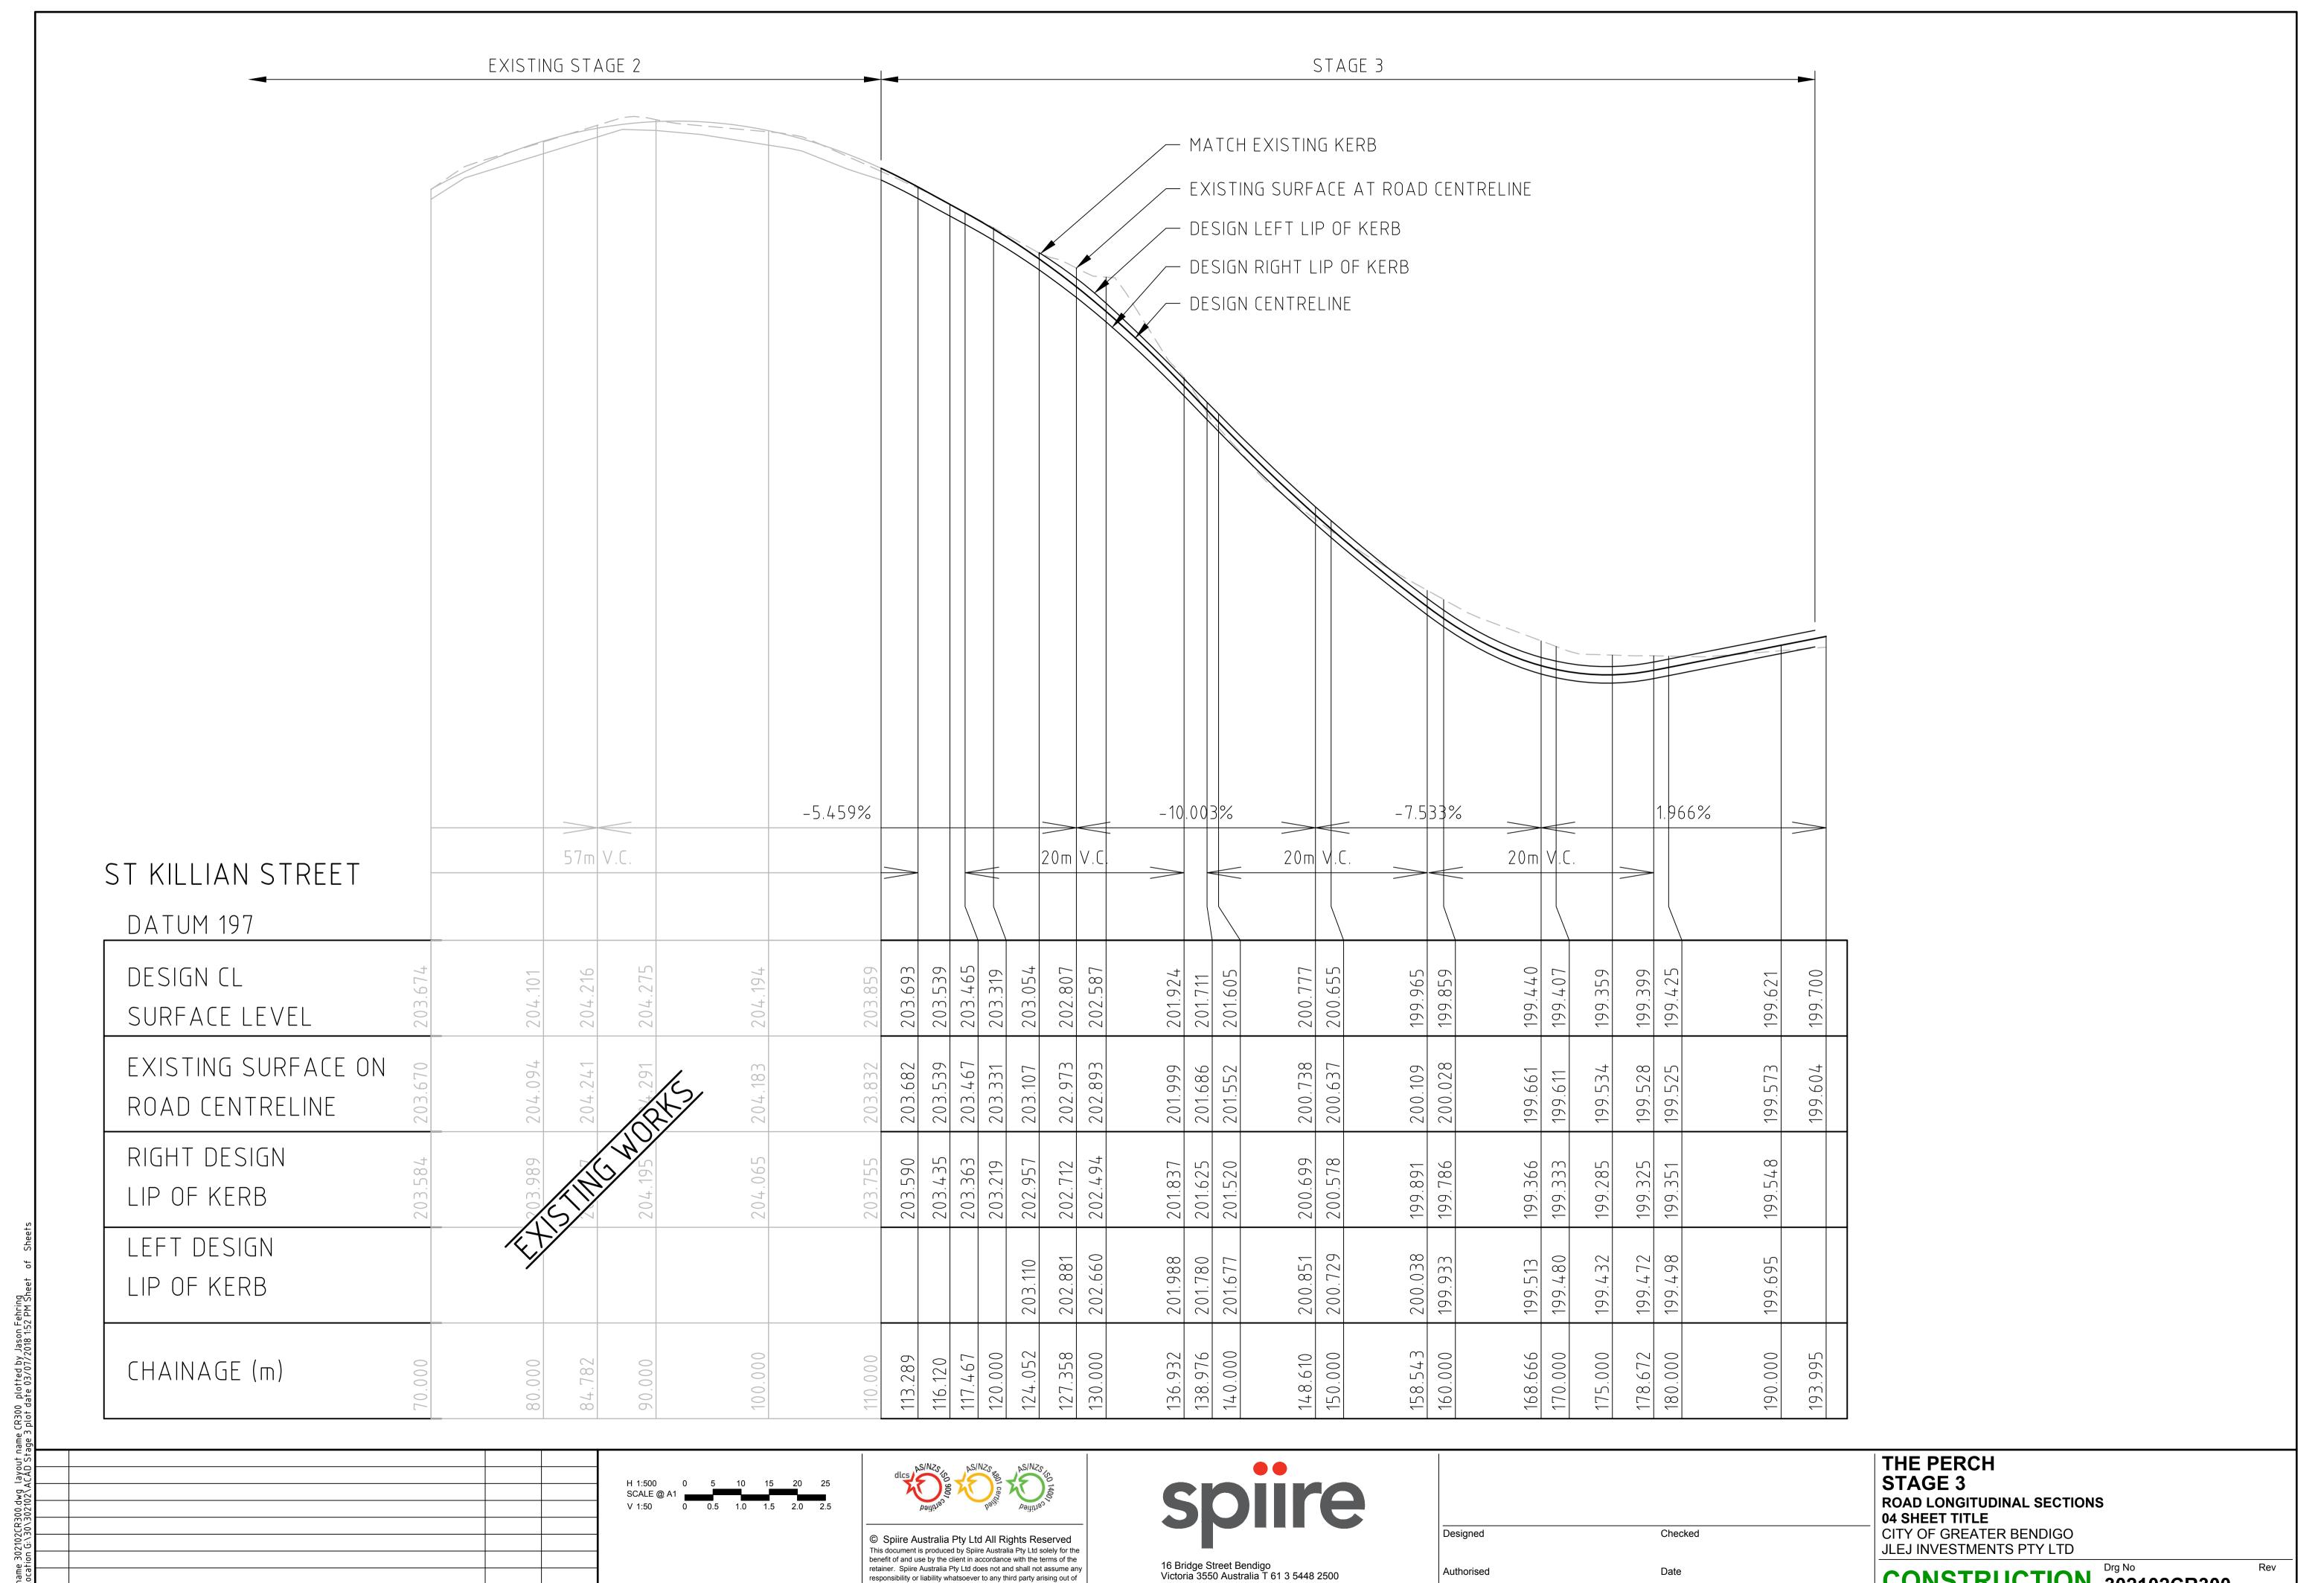


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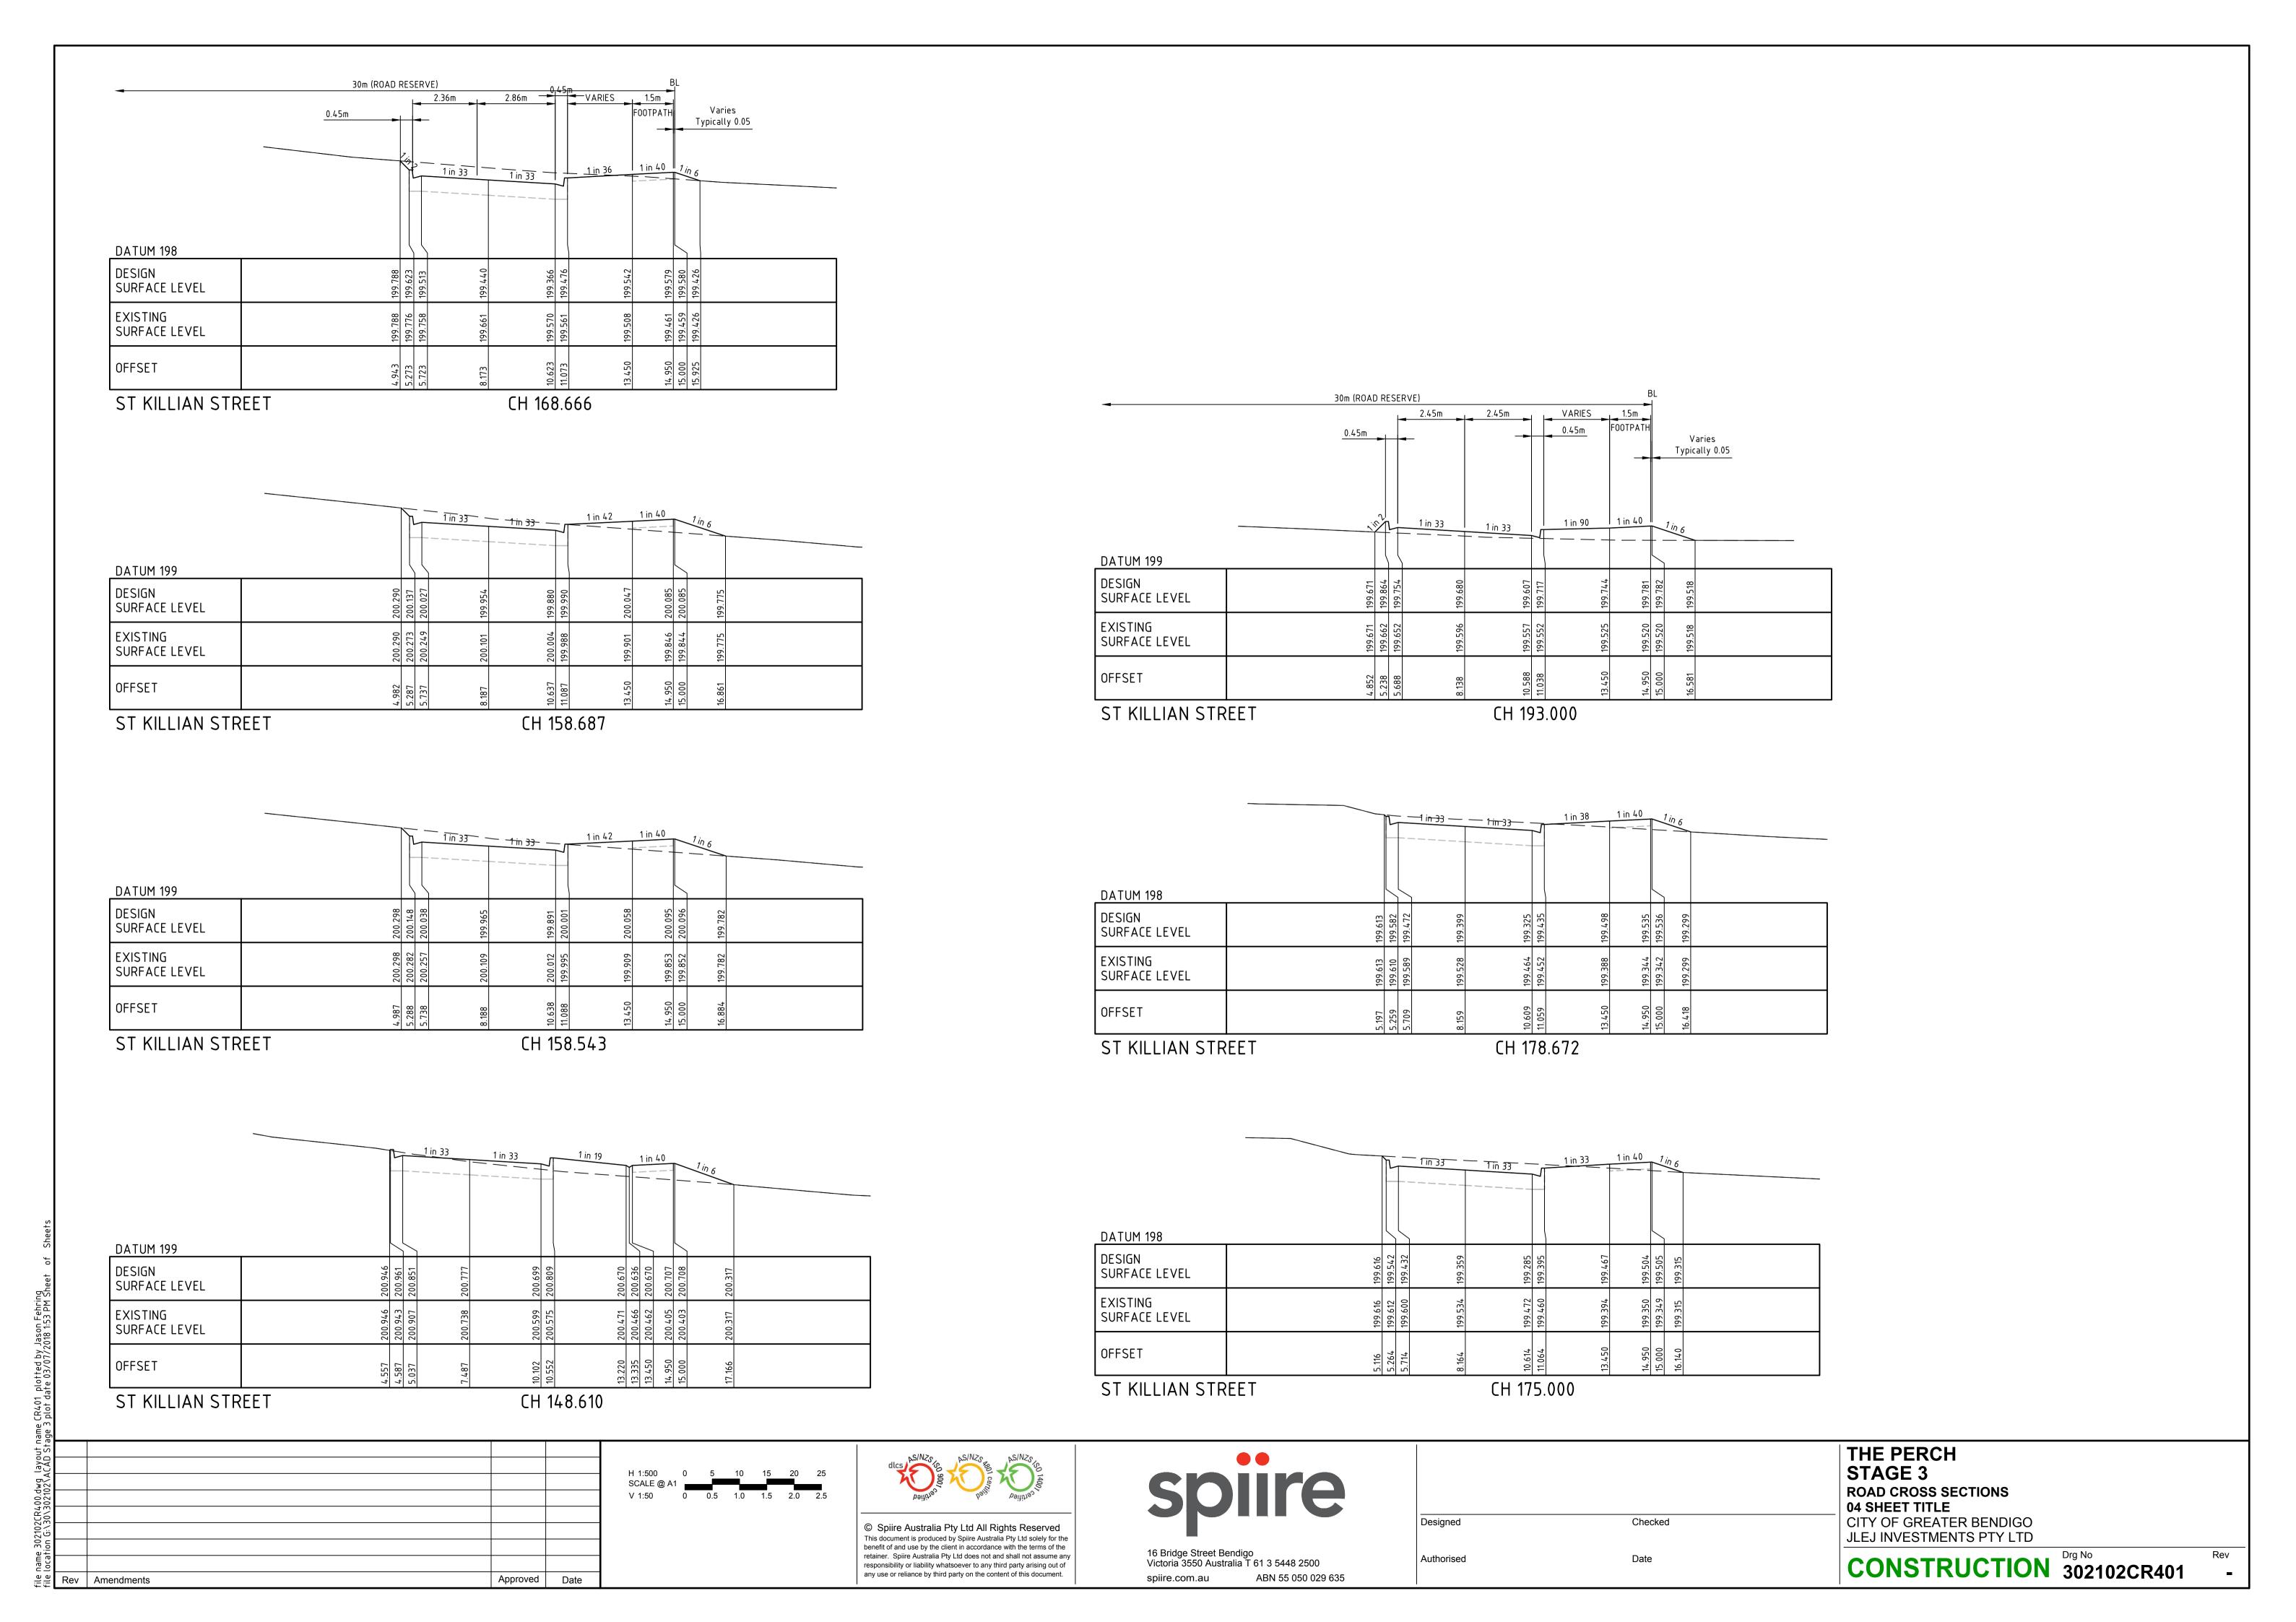
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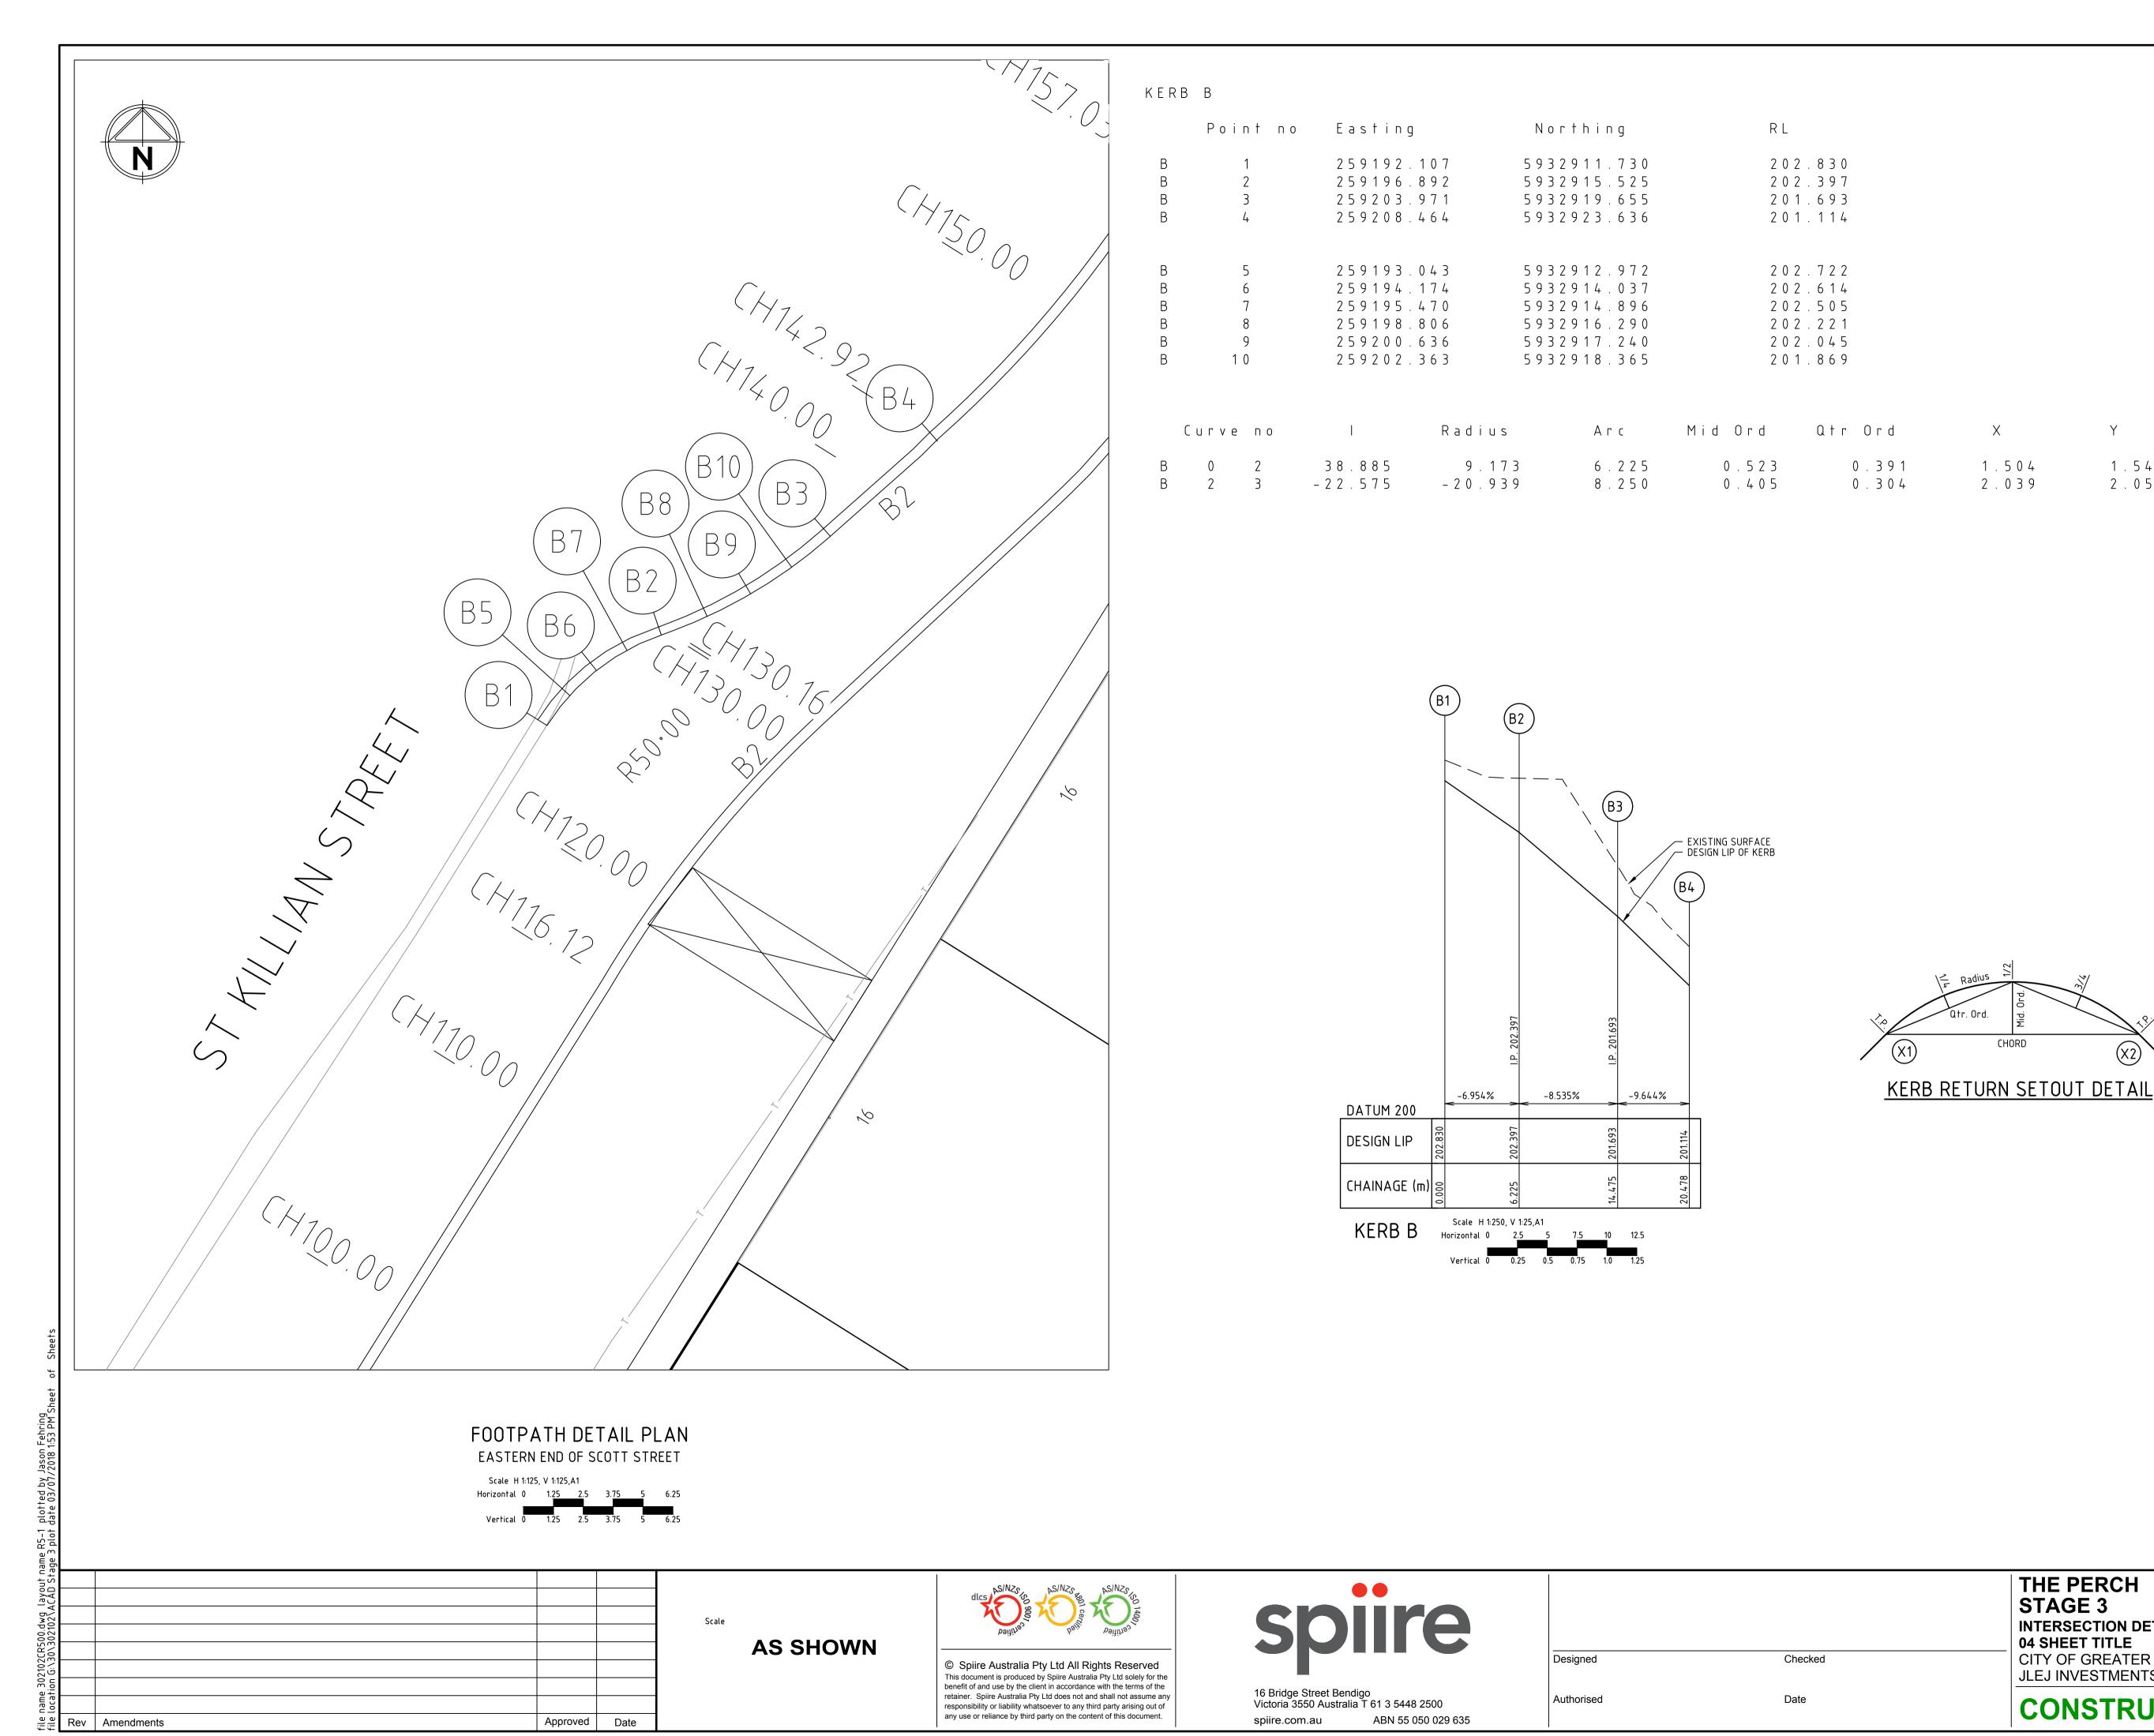
Approved

Rev Amendments

CONSTRUCTION 302102CR300





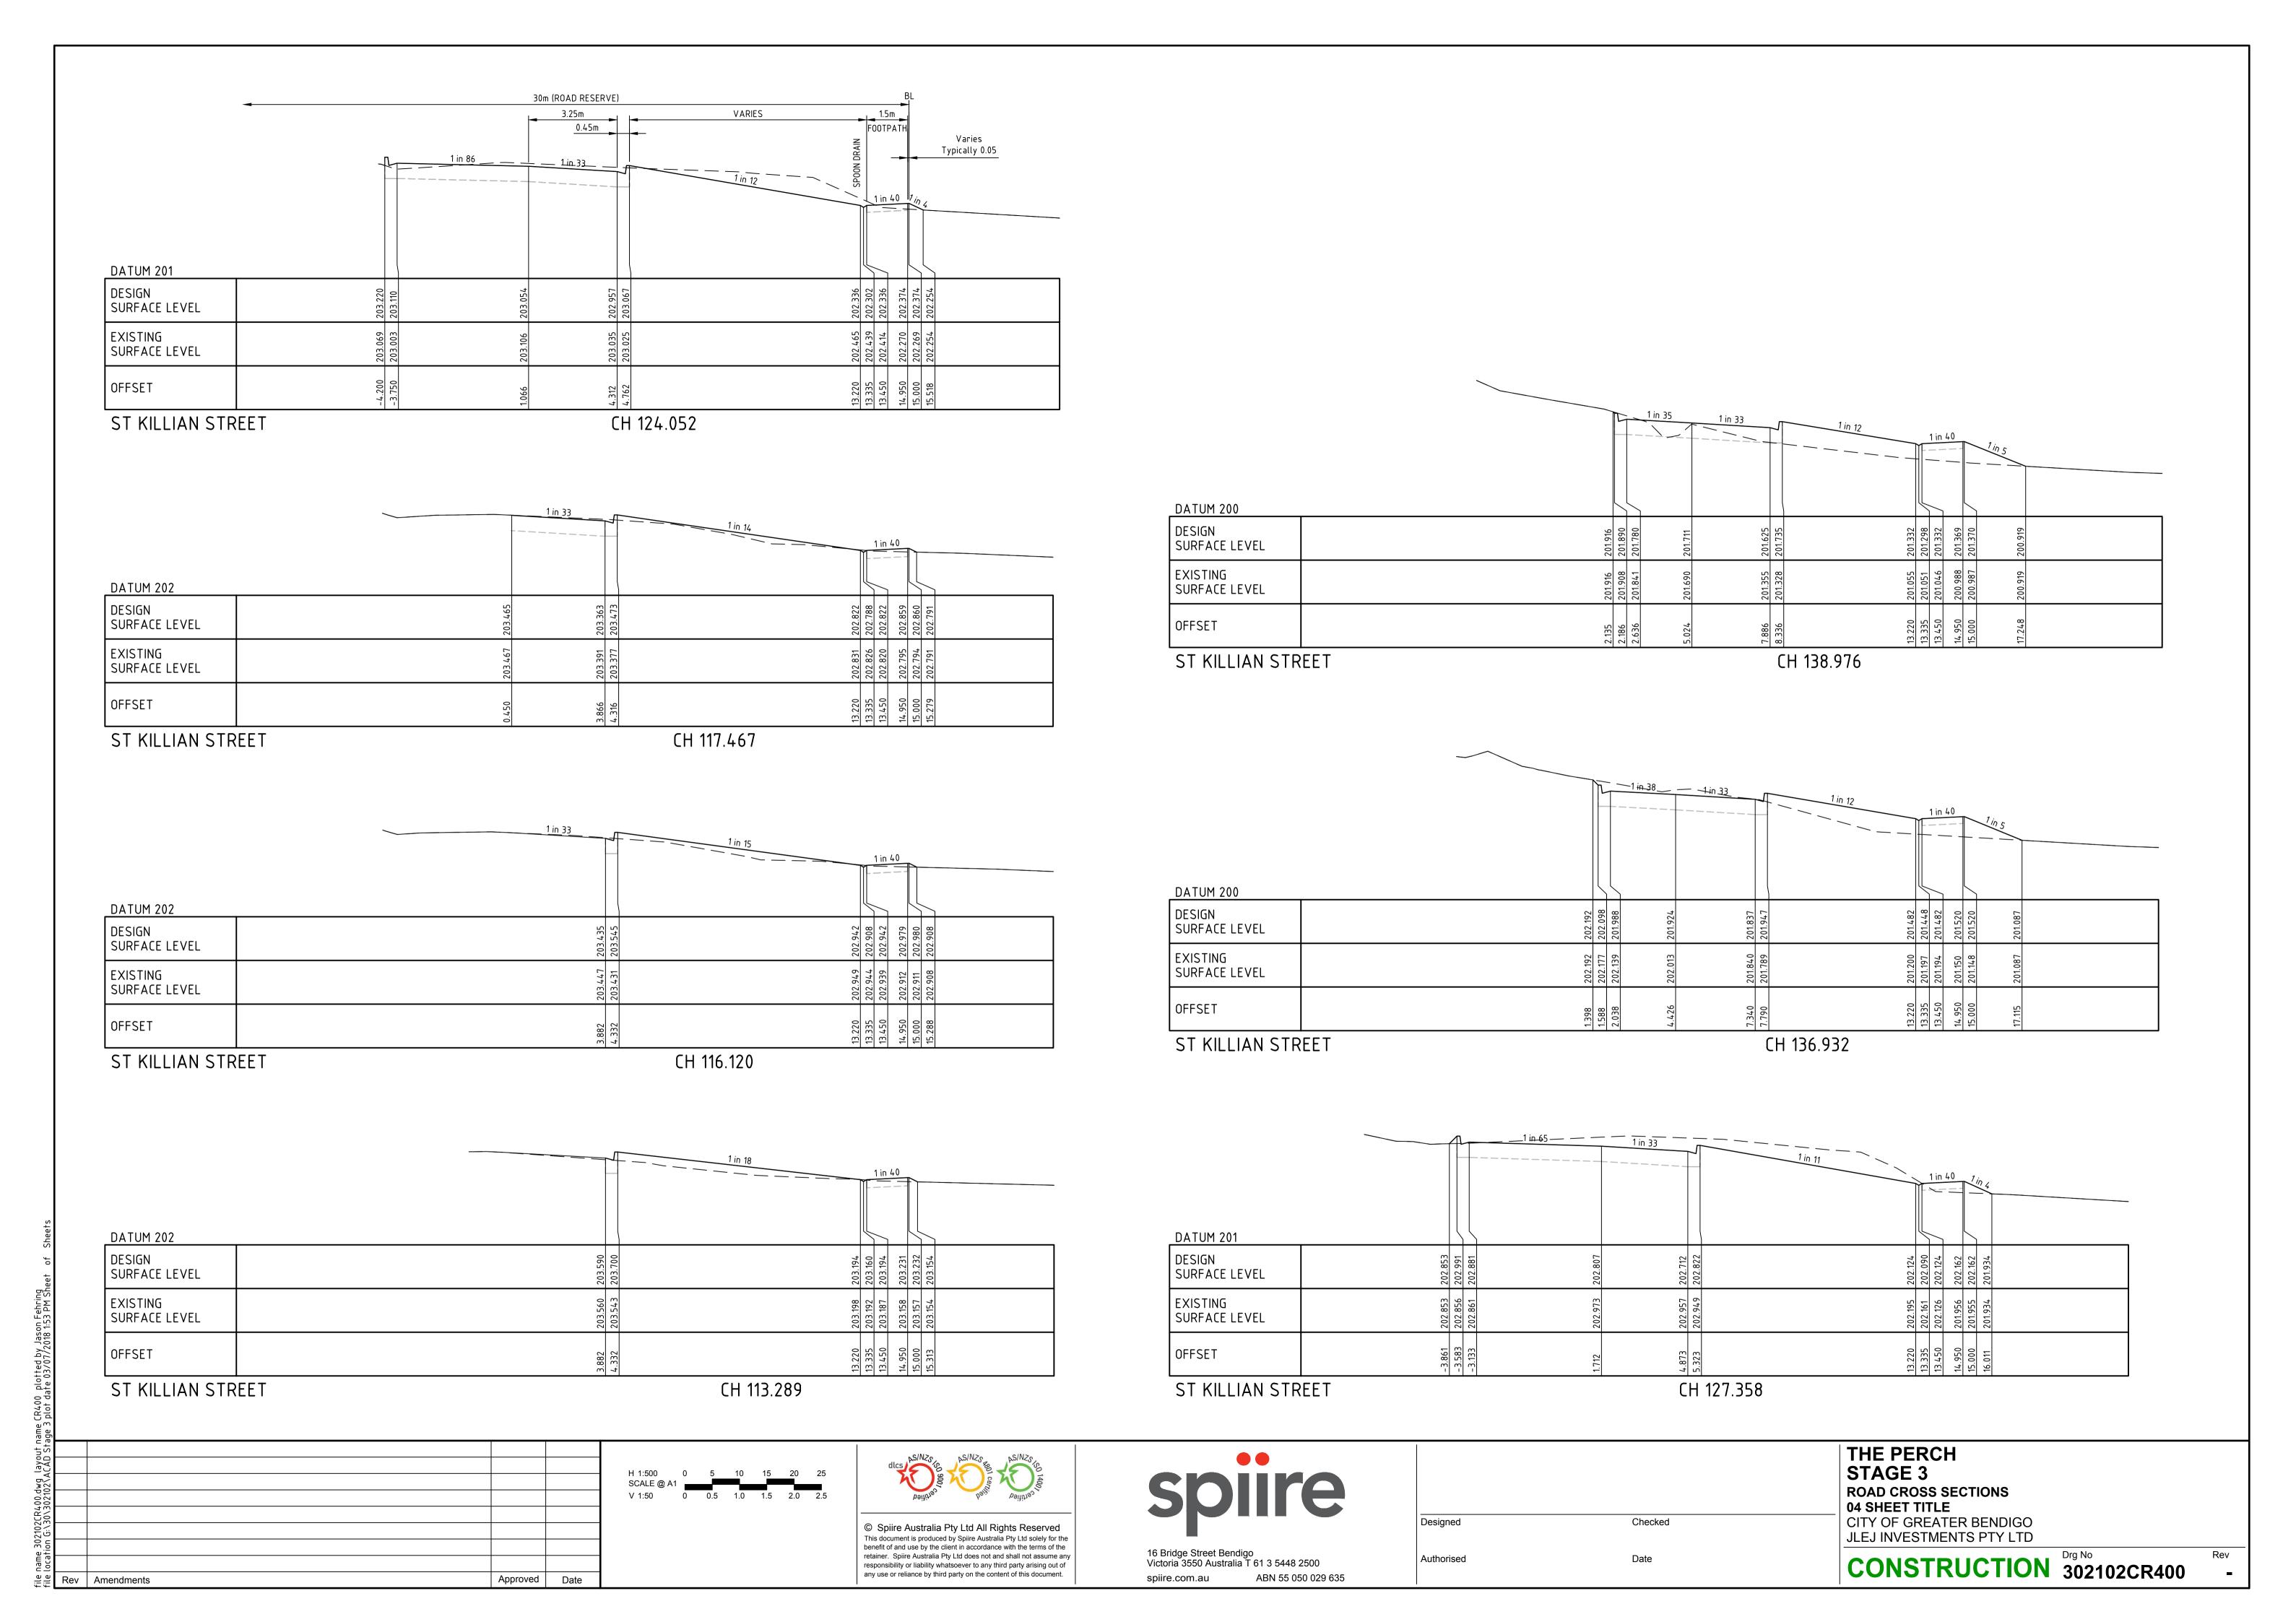

THE PERCH STAGE 3 **INTERSECTION DETAILS** 04 SHEET TITLE
CITY OF GREATER BENDIGO
JLEJ INVESTMENTS PTY LTD

CONSTRUCTION 302102R5-1

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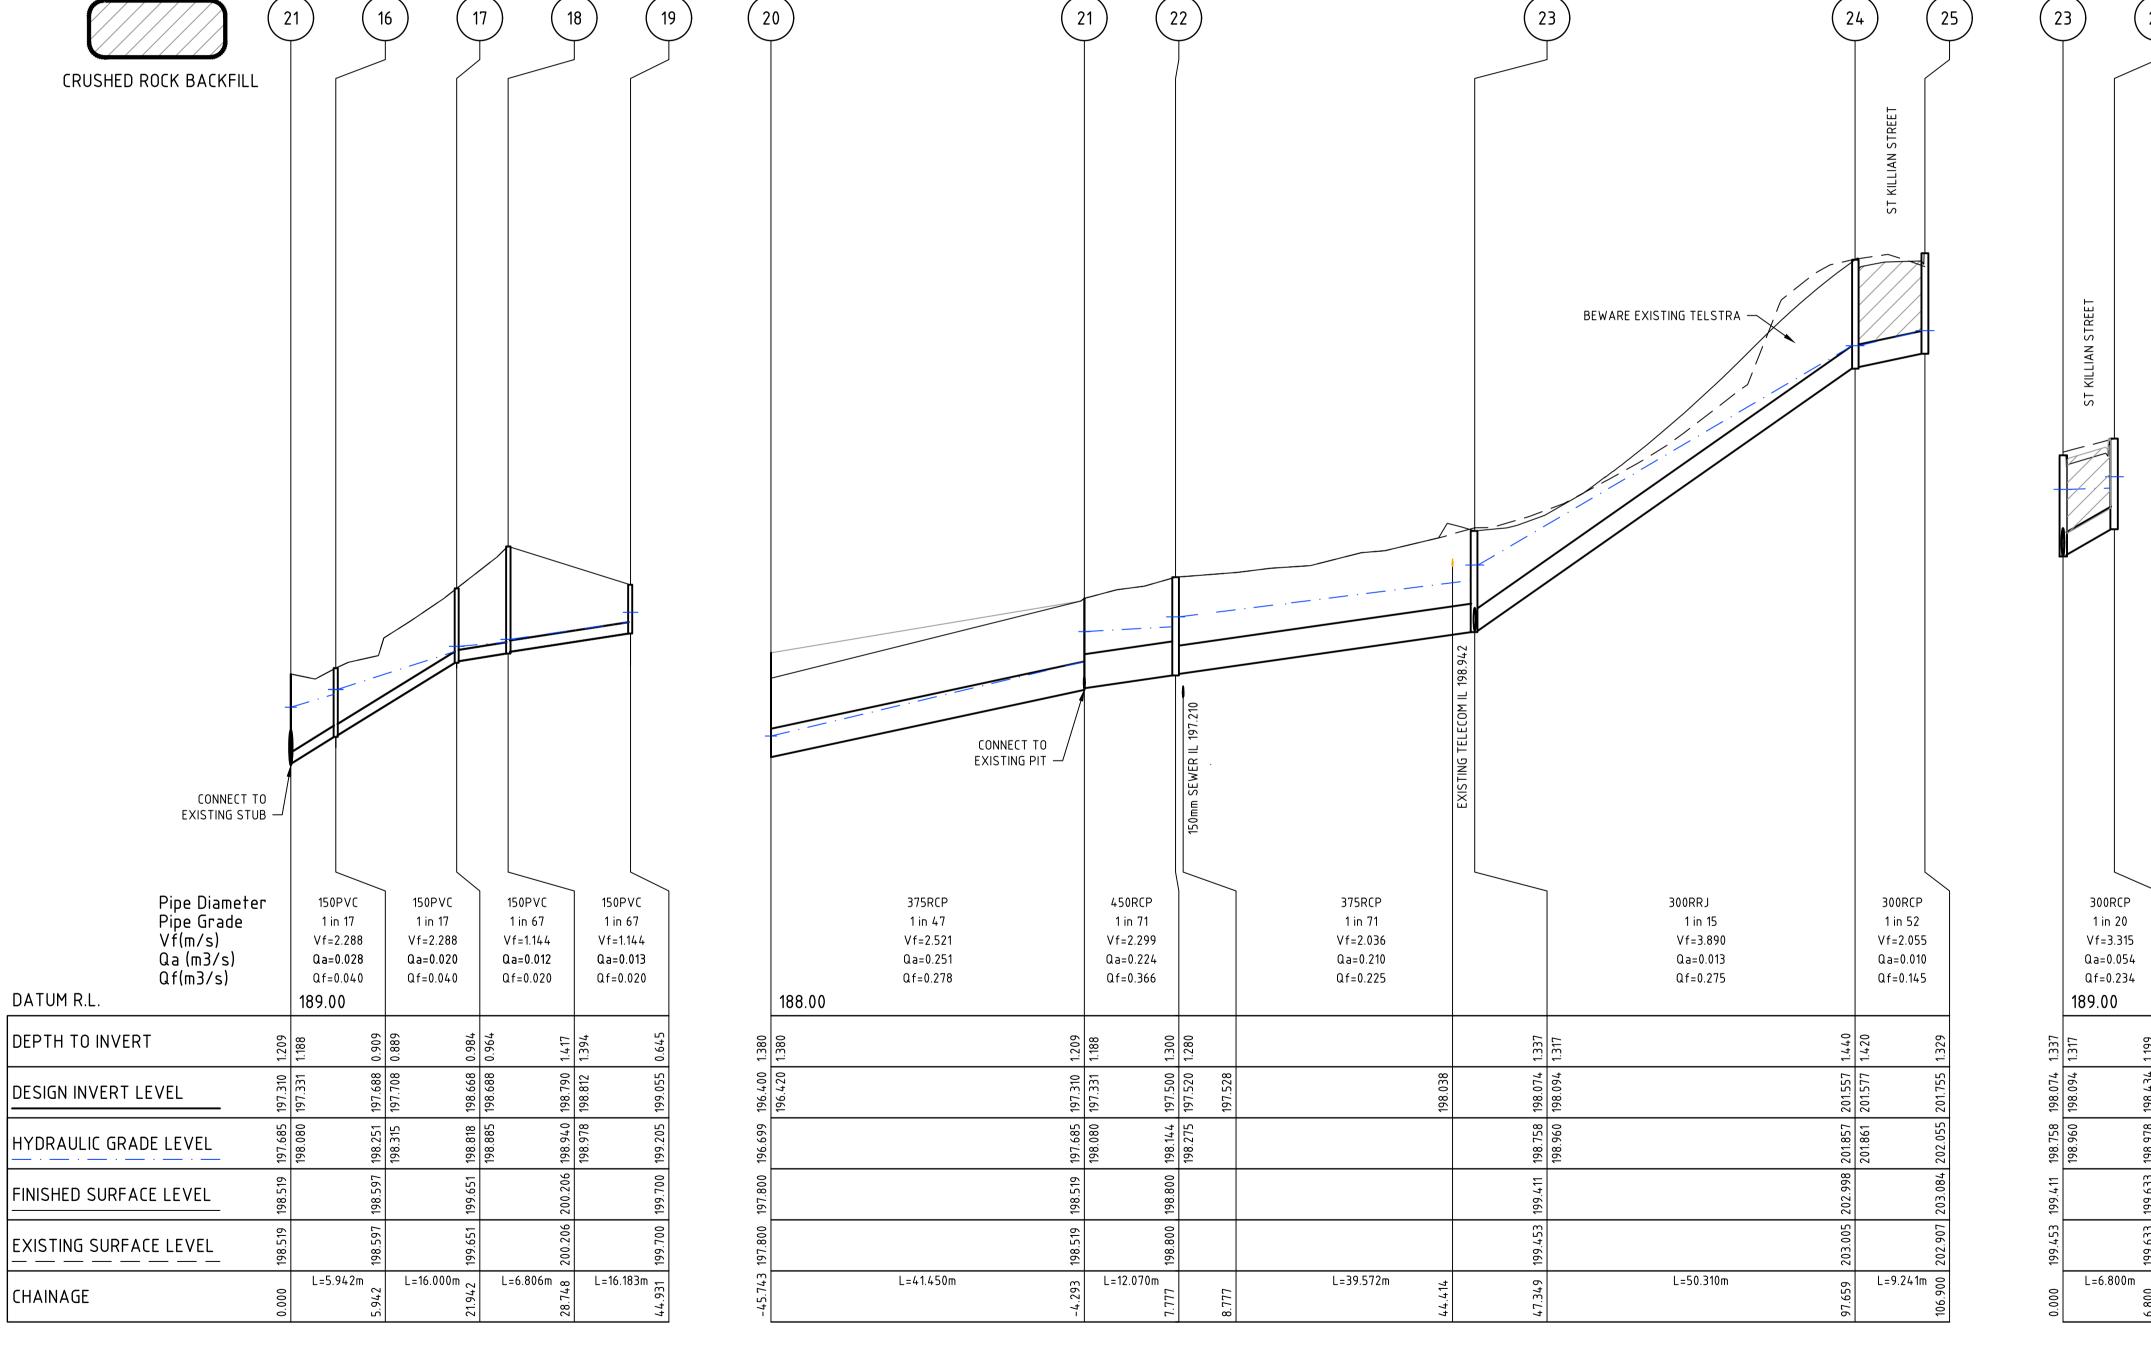
# DRAINAGE PIT SCHEDULE

	PIT	SET OUT CO-ORDINATES			INTERNAL DIMENSIONS		INLET	ou	TLET	PI	Γ	
No.	TYPE	EASTING	NORTHING	WIDTH	LENGTH	DIA	INV LEVEL	DIA	INV LEVEL	FS LEVEL	DEPTH	REMARKS
16	GEP	259255.543	5932909.902	450	450	150	197.708	150	197.688	198.597	0.91	
17	GEP	259247.030	5932896.355	450	450	150	198.688	150	198.668	199.651	0.98	
18	GEP	259243.409	5932890.592	600	900	150	198.812	150	198.790	200.206	1.42	
19	GEP	259254.965	5932879.263	450	450			150	199.055	199.700	0.65	
20	EXISTING PIT	259294.643	5932893.648	0	0	375	196.420	375		197.800	1.38	
21	EXISTING GEP	259258.971	5932914.756	600	900	150	197.331	375		198.519	1.21	CONNECT TO EXISTING PIT
						450	197.331	375	197.310			
22	GEP	259265.120	5932925.143	600	900	375	197.520	450	197.500	198.800	1.30	
23	SEP	259231.613	5932946.196	600	900	300	198.094	375	198.074	199.411	1.34	REFER IDM STD DRG 430
						300	198.094	375				
24	SEP	259199.965	5932907.504	600	900	300	201.577	300	201.557	202.998	1.44	REFER IDM STD DRG 430
25	SEP	259192.976	5932913.549	600	900			300	201.755	203.084	1.33	REFER IDM STD DRG 430
26	SEP	259225.855	5932949.813	600	900			300	198.434	199.633	1.20	REFER IDM STD DRG 430

NOTES:

1. PIT SETOUT COORDINATES ARE TO PIT CENTRE

2. PIT FS LEVEL IS TO PIT COVER LEVEL





- 1. ALL DRAINAGE PIPES & PITS ARE TO BE AT 1m OFFSET TO PROPERTY BOUNDARIES UNLESS SHOWN OTHERWISE
- 2. THE CONTRACTOR MUST CONTACT SERVICING AUTHORITIES TO ARRANGE SERVICE LOCATIONS PRIOR TO COMMENCEMENT OF EXCAVATION FOR THIS PROJECT.
- 3. PITS ARE TO BE CONSTRUCTED IN ACCORDANCE WITH THE CURRENT STANDARDS OF THE MUNICIPALITY. STEEL GRATES ARE TO BE HOT DIP GALVANISED AFTER MANUFACTURE. THE TOP OF ALL GRATES MUST BE APPROXIMATELY 150mm BELOW THE SURROUNDING SURFACE LEVEL. PROPERTY DRAINAGE CONNECTIONS ARE TO BE PROVIDED AS NECESSARY.
- 4. ALL SIDE ENTRY PITS IN ROLLOVER KERB & CHANNEL ARE TO BE CONSTRUCTED USING AN APPROVED ROLLOVER TYPE LINTEL OR A REINFORCED ROLLOVER PROFILE PIT LID. STANDARD SQUARE PROFILE PIT LIDS WITHOUT LINTEL ARE NOT ACCEPTABLE.
- TRENCHES WITHIN PAVEMENT OR FOOTPATH AREAS ARE TO BE BACKFILLED WITH 3% CEMENT STABILISED CLASS 1 FCR. THE TRENCH IS TO BE BACKFILLED IN 150MM LAYERS AND CONSOLIDATED.
- 6. ALL PIPE STUBS ARE TO CONSIST OF ONE FULL PIPE LENGTH UNLESS
- 7. FINISHED LEVELS FOR SIDE ENTRY PITS MUST BE DETERMINED FROM KERB LEVELS AND SHOULD BE SLOPED TO SUIT NATURESTRIPS ETC. THE FSLS INDICATED IN THE PIT SCHEDULE ARE NOT KERB LEVELS.
- 8. STEP IRONS ARE NOT REQUIRED IN DRAINAGE PITS.
- 9. CONCRETE PIPES ARE TO BE CLASS 2 FJ RCP AND PVC PIPES ARE TO BE CLASS SN8 UNLESS OTHERWISE NOTED.
- 10. ALL EXCAVATIONS FOR DRAINAGE WORKS ARE TO BE CARRIED OUT IN ACCORDANCE WITH THE REQUIREMENTS OF THE VICTORIAN WORK COVER AUTHORITY.
- 11. REINFORCEMENT BARS SHALL COMPLY WITH AS1302/1991, GRADE 400Y. LAPS IN REINFORCEMENT BARS SHALL BE 300 MIN. AND CLEAR COVER 50 MIN.
- 12. CONCRETE SHALL BE NORMAL CLASS N32 STANDARD STRENGTH GRADE OR HIGHER COMPLYING WITH THE REQUIREMENTS OF AS1379.
- 13. ENDWALLS SHALL BE CONSTRUCTED IN ACCORDANCE WITH THE RELEVANT PROVISIONS OF AS3600.
- 14. DIRECT CONNECTION OF PVC HOUSE DRAIN TO RCP DRAINAGE TO BE CONSTRUCTED WITH "CONCONECT" OR APPROVED EQUIVALENT FITTING. 150mmø PVC PIPES ARE NOT TO BE DIRECTLY CONNECTED TO CONCRETE PIPES LESS THAN 450mmø IN DIAMETER. WHERE FURTHER SUBDIVISION OF THE LOT CONCERNED IS NOT PRACTICAL A 100mmø HOUSE CONNECTION PIPE MAY BE USED.
- 15. WHERE PVC HOUSE CONNECTIONS ARE MADE DIRECTLY TO PIPES, THE HOUSE CONNECTION IS TO BE RAISED TO SURFACE LEVEL WITHIN THE PROPERTY AND CAPPED AS PER SD520.
- 16. COMPACTION REQUIREMENTS ANY BACKFILL WITHIN 1m OF A COUNCIL ASSET (EG FOOTPATH OR ROAD) IS REQUIRED TO BE FCR. ALTERNATIVELY OTHER FILL MATERIAL CAN BE USED PROVIDED COMPACTION TESTS ARE CARRIED OUT TO ENSURE 95% COMPACTION IS ACHIEVED. TESTS TO BE CARRIED OUT AT A MINIMUM OF 1 PER 60m OF TRENCH.

Rev	Amendments	Approved	Date





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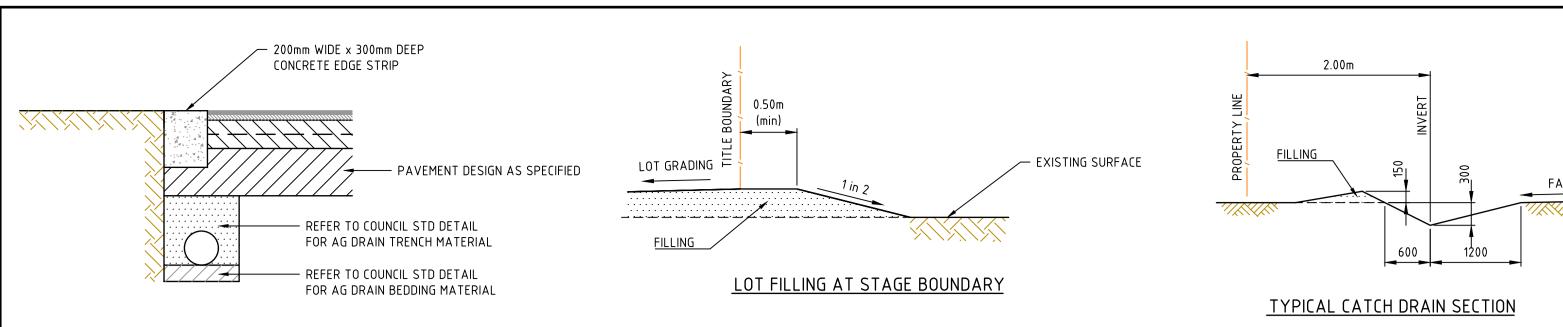


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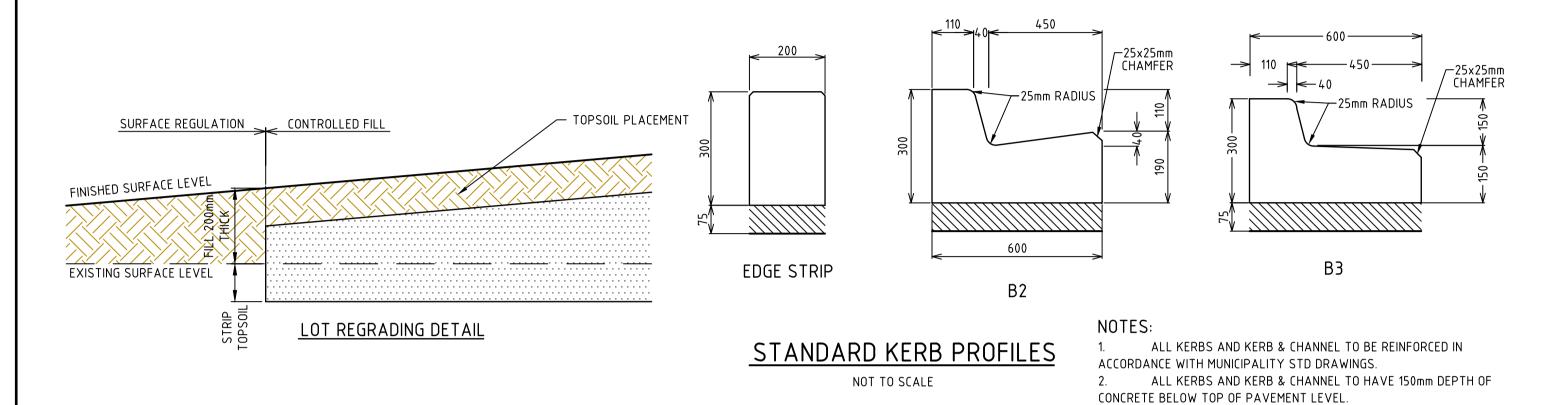
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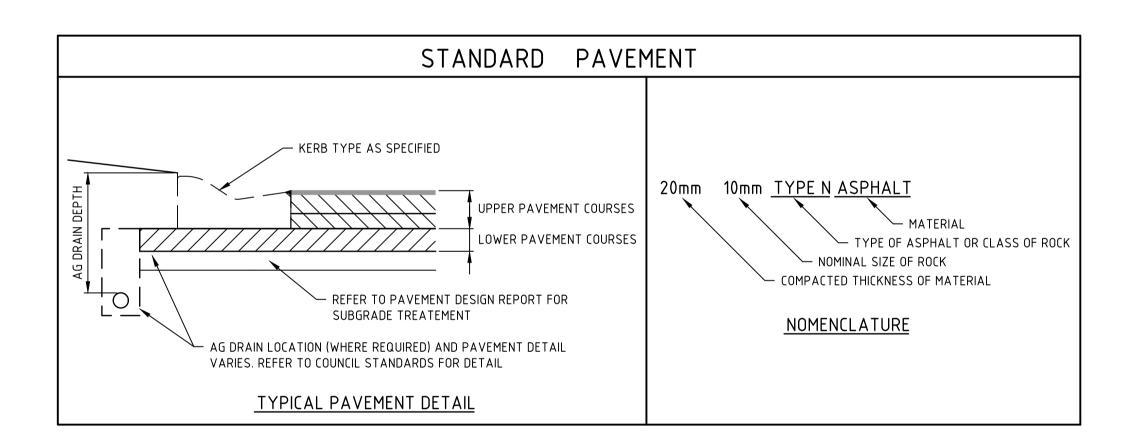
THE PERCH
STAGE 3
DRAINAGE LONG SECTIONS
04 SHEET TITLE
CITY OF GREATER BENDIGO
JLEJ INVESTMENTS PTY LTD

CONSTRUCTION 302102CR600



# LIMIT OF WORKS CONCRETE EDGE STRIP & PAVEMENT INTERFACE - DETAIL






PAVEMENTS											
STREET NAME	ST. KILLIAN ST (WIDENING) SCOTT ST (WIDENING)	ST. KILLIAN ST (CH120–194) (REFER GTS Report 16C 0197) To be revised subject to re–approval.									
PAVEMENT THICKNESS	250	370									
ASPHALT SEAL (mm) WITH PRIME	30mm	30mm									
BASE COURSE (mm) CLASS 2 20mm FCR.	120mm	14 0 m m									
SUBBASE BASE (mm) CLASS 3. 20mm or 40mm FCR.	100mm	200mm									

# GENERAL NOTES


- PAVEMENT DETAILS SHOWN ABOVE
   NATURE STRIPS ARE TO BE TOPSOILED WITH MATERIAL STOCKPILED FROM STRIPPING TO A DEPTH OF 100mm. IMPORTED TOPSOIL AND/OR SEEDING MAY
- BE REQUIRED TO PROVIDE GOOD GRASS COVER.

  3. LOCATION OF ALL SERVICE CONDUITS IS TO BE MARKED ON THE FACE OF BOTH KERBS WITH A UNIFORM 50mm DIAMETER MARK, 5mm DEEP. WATER & GAS CONDUITS TO BE 50mm DIAMETER CLASS 12 uPVC PIPE. POWER & TELSTRA CONDUITS ARE AS SPECIFIED ON THEIR RESPECTIVE PLANS.

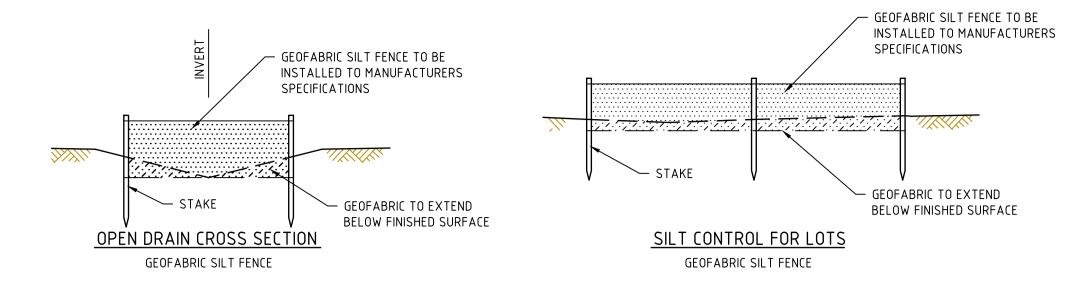

# SILT CONTROL OPTIONS

NOT TO SCALE

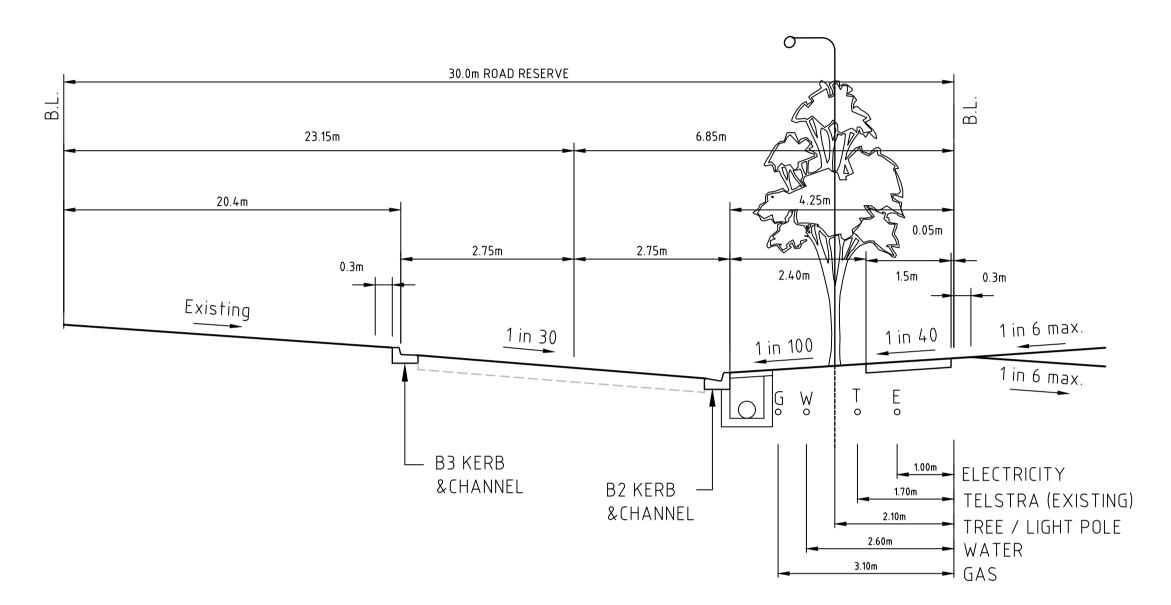


# ST KILLIAN STREET 5.5m CARRIAGEWAY (CH157.03-194.03)

Designed Checked

Authorised Date

THE PERCH
STAGE 3
PAVEMENT AND TYPICAL DETAILS
04 SHEET TITLE
CITY OF GREATER BENDIGO
JLEJ INVESTMENTS PTY LTD

CONSTRUCTION 302102CR700

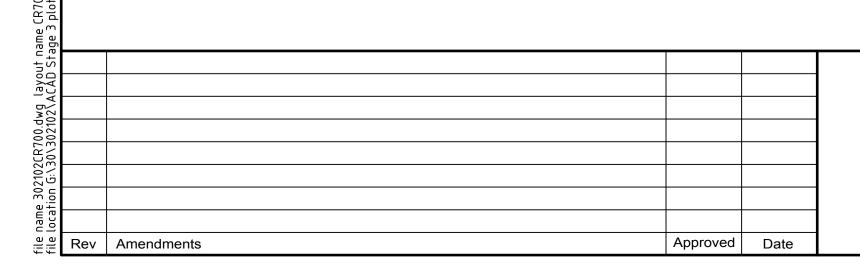

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# THE PERCH - STAGE 3 73-77 KENNEWELL ST, WHITE HILLS JLEJ INVESTMENTS PTY LTD POTABLE WATER RETICULATION

## WATER NOTES:

- ALL WORKS TO BE IN ACCORDANCE WITH WSA 03-2011-3.1 WATER SUPPLY CODE OF AUSTRALIA, MELBOURNE RETAIL WATER AGENCIES EDITION, VERSION 1.0 AND THE COLIBAN WATER SUPPLEMENT TO THE
- 2. ALL MATERIALS ARE TO BE IN ACCORDANCE WITH COLIBAN WATER'S PREFERRED EQUIPMENT MANUFACTURERS LIST.
- 3. ALL DIMENSIONS ARE IN METRES UNLESS OTHERWISE NOTED.
- 4. ALL LEVELS ARE IN METRES AND TO A.H.D.
- 5. CLASS 3 FCR BACKFILL MUST BE USED WHERE MAINS ARE LOCATED UNDER ROADWAYS, DRIVEWAYS OR FOOTPATHS.
- 6. ALL D.I.C.L. PIPES TO BE INSTALLED WITH POLYETHYLENE SLEEVES. DICL PIPES INSTALLED UNDER ROADWAYS ARE TO EXTEND AT LEAST 3M BEYOND THE EXTENSION OF THE PROPERTY LINES. ALL TEE'S AND BENDS TO BE DICL
- 7. ALL VALVES TO BE A.S.2638 CLASS 14 ANTI CLOCKWISE CLOSING.
- 8. ALL FLANGES TO BE A.S.2129 TABLE "C".
- 9. TRAFFIC MANAGEMENT TO BE IN ACCORDANCE WITH A.S.1742.3 (TRAFFIC CONTROL DEVICE FOR WORKS IN ROADS).
- 10. A 20 MPa CONCRETE THRUST OR SUPPORT BLOCK TO BE CONSTRUCTED BEHIND ALL BENDS, TEES, VALVES AND BLANK ENDS ON ALL WATER MAINS. FOR DETAILS REFER TO STANDARD DETAIL DRAWING No. WAT-1205.
- 11. ALL HANDLING OF ASBESTOS CEMENT PIPES & FITTINGS TO BE CARRIED OUT IN ACCORDANCE WITH GENERAL SPECIFICATION FOR CONSTRUCTION OF PRESSURE PIPES.
- 12. ALL GIBAULT, FLANGE & WELDED JOINTS, TAPPING SADDLE BOLTS & NUTS & VALVE STUFFING BOXES TO HAVE THE FOLLOWING PROTECTION: DENSO 300 PRIMER, 400 MASTIC, 600 TAPE & 931 OVERWRAP APPLIED IN ACCORDANCE WITH MANUFACTURER'S
- 13. GAS & WATER MAINS TO BE LAID IN A COMMON TRENCH.
- 14. LAY MAINS OVER DRAINS UNLESS SHOWN OTHERWISE.
- 15. USE EXTREME CARE WHEN WORKING NEAR EXISTING TREES TO MINIMISE DAMAGE TO ROOT SYSTEM & CANOPY.
- 16. ALL TREES MUST BE PRESERVED AND PROTECTED AT ALL TIMES. TREES MARKED X ON DESIGN PLANS MAY BE REMOVED.
- 17. NOTE TO CONTRACTOR: THE CONSULTING ENGINEER IS RESPONSIBLE FOR THE DESIGN OF THE WORKS. ANY PROBLEMS ARISING DURING THE CONSTRUCTION SHALL BE DIRECTED TO THE CONSULTANT.
- 18. NO BLASTING IS PERMITTED WITHIN 20m OF EXISTING WATER MAINS.
- 19. THE LOCATION AND DEPTH OF ANY EXISTING SERVICES SHOULD BE DETERMINED BY THE CONTRACTOR PRIOR TO COMMENCING ANY EXCAVATION BY CONTACTING ALL LOCAL SERVICE AUTHORITIES. FOR ASSISTANCE IN LOCATING SERVICES OR IN AN EMERGENCY, TELEPHONE "DIAL BEFORE YOU DIG" (Ph 1100)
- 20. THE MAXIMUM DEPTH FROM THE SURFACE LEVEL TO TOP OF PIPE MUST NOT EXCEED 1.50m.
- 21. CONTRACT IS IN ACCORDANCE WITH AS2124-1992

INITIAL PRE-DESIGN PLANS

REV

- 22. THIS DESIGN COMPLIES WITH COLIBAN WATER STANDARDS AND THE SUPPLY OFFER WME xxxxx DATED xxxxxxx
- 23. IT IS THE CONTRACTORS RESPONSIBILITY TO ENSURE DISINFECTION OF WATER MAINS IS TO BE CARRIED OUT STRICTLY IN ACCORDANCE WITH WSA 03-2011-3.1 APPENDIX I "DISINFECTION OF WATER MAINS"

22-05-18

TOTAL WORK SCHEDULE											
SIZE (mm)	TYPE	CLASS	LENGTH (m)								
100	mPVC	PN 16	30								

#### WARNING BEWARE OF UNDERGROUND/OVERHEAD SERVICES

THE LOCATION OF SERVICES ARE APPROXIMATE ONLY AND THEIR EXACT POSITION SHOULD BE PROVEN ON SITE. NO GUARANTEE IS GIVEN THAT ALL EXISTING SERVICES ARE SHOWN.SPECIAL CONSIDERATION SHOULD BE GIVEN TO CONSTRUCTION PROCEDURES UNDER OVERHEAD ELECTRICITY TRANSMISSION LINES.




# SERVICE LOCATION TABLE

	ROAD NAME	POTABLE WATER		GAS		NE (TELI	BN ECOM)	ELECTRICITY				
		SIDE OFFS	OFFSET	FFSET SIDE	OFFSET	SIDE	OFFSET	POLE		U/G CABLE		
		SIDE		SIDE	UFFSET	SIDE	UFFSET	SIDE	OFFSET	SIDE	OFFSET	
	KENNEWELL STREET	W	3.4 (EX)	Е	4.0 (EX)	W	1.5 (EX)	E	3.0 (EX)	Е	4.5	
	SCOTT STREET	N	5.0 (EX)	N	3.6 (EX)	N	2.6 (EX)	1	-	-	-	
	ST KILLIAN STREET (CH 7.00 - 28.00)	Е	7.75	Е	Varies	Е	2.7	W	4.0 (EX)	Е	2.2	
	ST KILLIAN STREET (CH 47.00 - 100.00)	Е	3.95	Е	4.4	Е	2.7	W	4.0 (EX)	Е	2.2	
STAGE 2	ST KILLIAN STREET (CH 100.00 – 130.16)	E	3.95-3.1	E	4.4-3.55	E	Varies	-	-	E	Varies	
STAGE 3	ST KILLIAN STREET (CH 130.16 – 194.03)	E	2.5	E	2.95	Е	1.75 (EX)	-	-	E	1.0	

1. TELECOMMUNICATIONS AND ELECTRICITY CABLES TO BE CONSTRUCTED IN A COMMON TRENCH IN ACCORDANCE WITH ELECTRICITY AUTHORITY STANDARD DRG's.

DRAWN

- GAS AND WATER MAINS TO BE CONSTRUCTED IN A COMMON TRENCH.
- 3.  $\times$  = OFFSET FROM BACK OF KERB 4. (EX) = SERVICE IS EXISTING
- 5. (Var) = SERVICE OFFSET CAN VARY IN SECTIONS

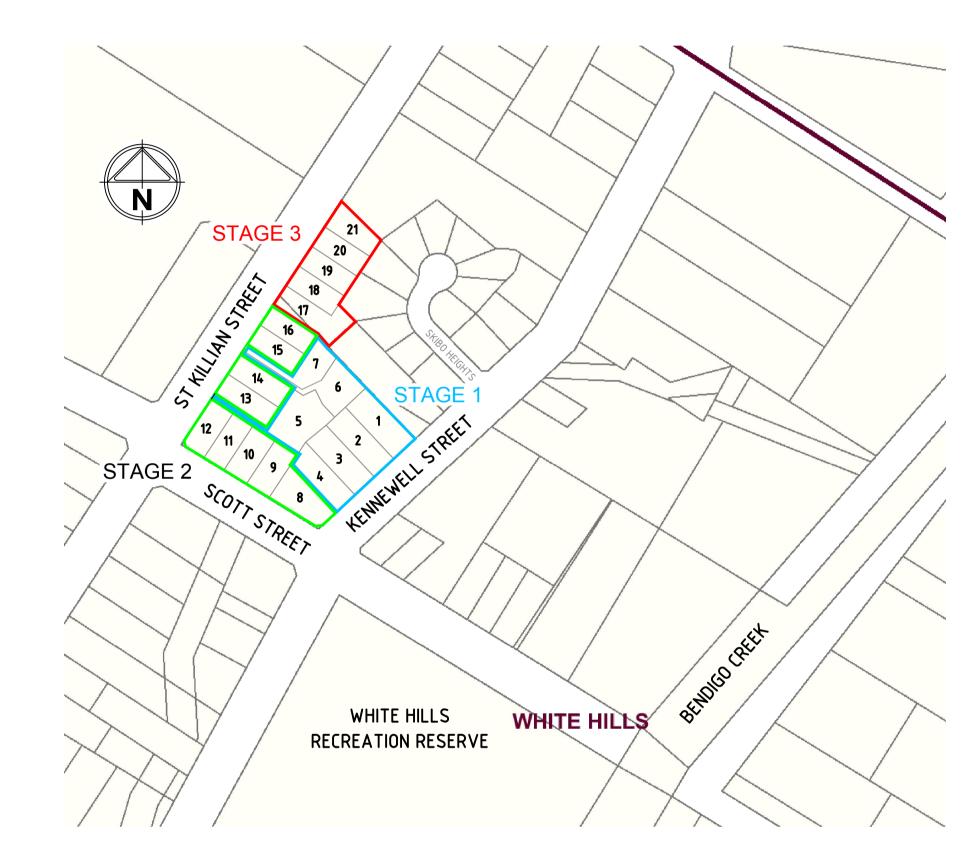

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	DESIGNED	16	PROJECT	WME 18151	
	DESIGNED	JF	NUMBER	VVIVIL TOTOT	II E I INIVECTRAENTO
					II F I INVESTMENTS

MELWAY

REFERENCE

16 Bridge Street Bendigo Victoria 3550 Australia T 61 3 5448 2500 ABN 55 050 029 635



### COLIBAN WATER CITY OF GREATER BENDIGO THE PERCH


STAGE 3 302102CW100 WATER RETIC GENERAL NOTES

SCALE: NOT TO SCALE SHEET: 1 OF 2 DRAWING No.:

12

CHECKED AUTHORISED DATE APPROVED REV DESCRIPTION APPROVED DESCRIPTION DATE

**PTY LTD** 

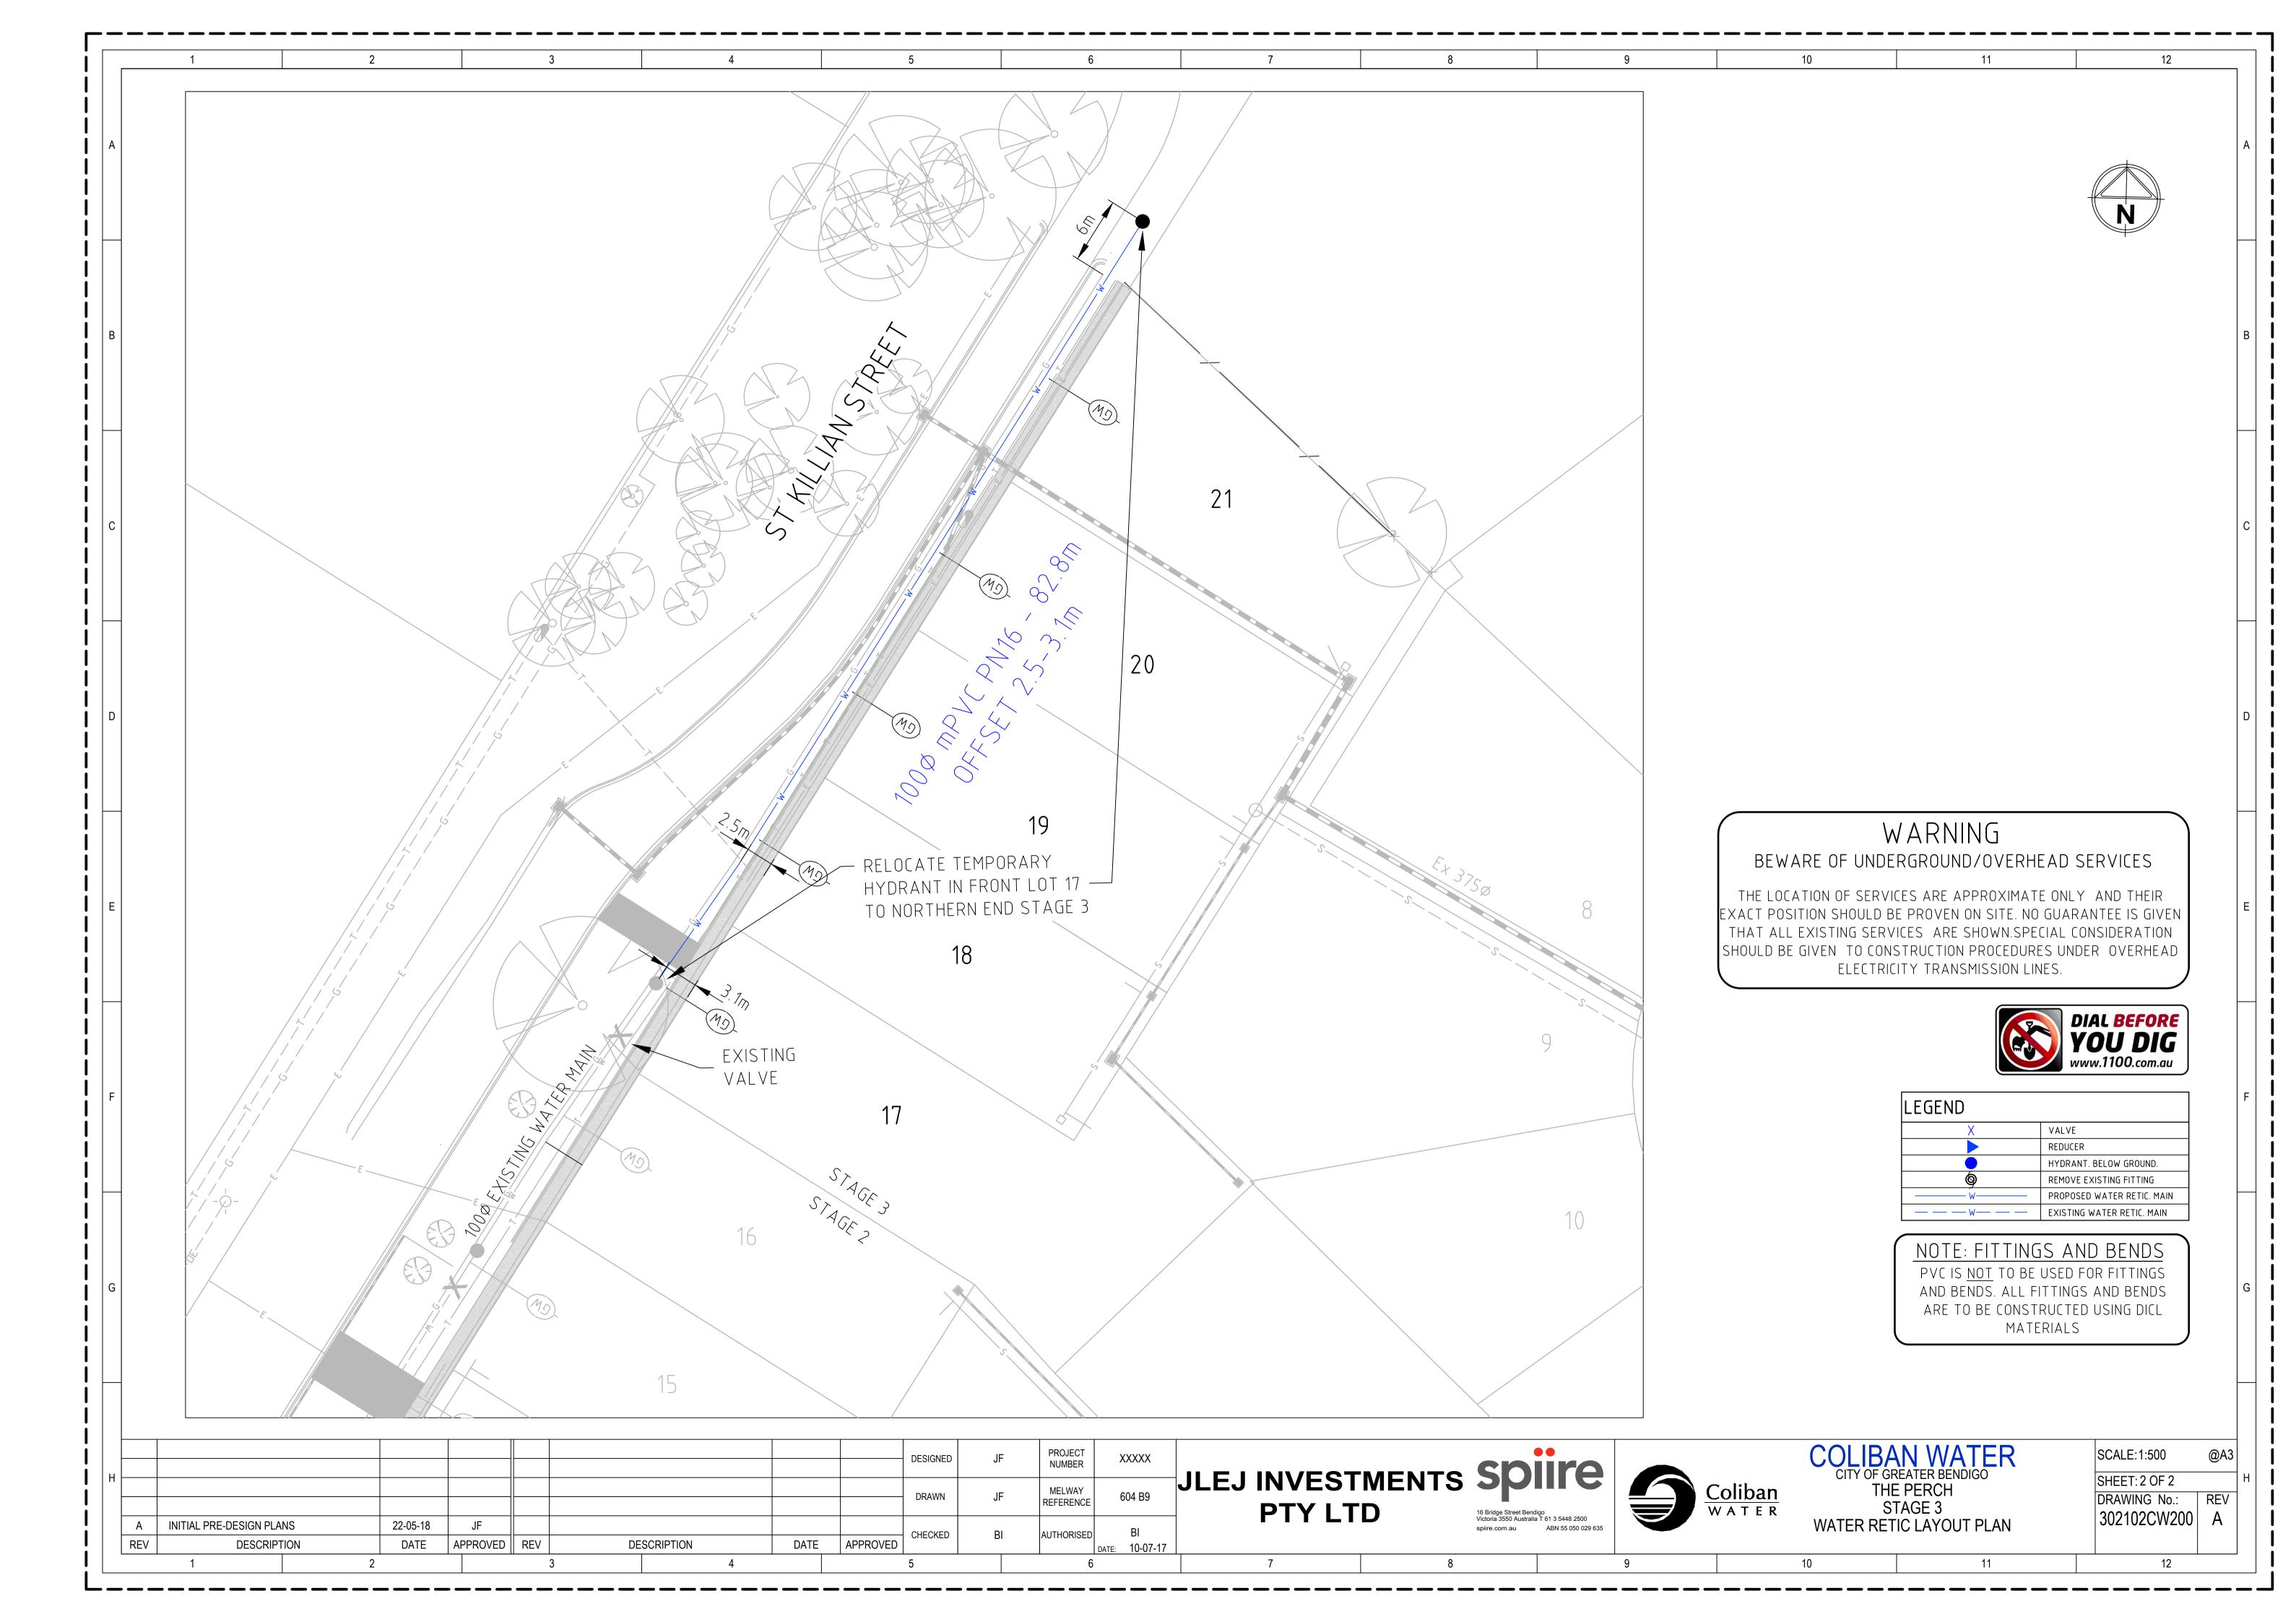

# THE PERCH STAGE 3 JLEJ INVESTMENTS PTY LTD SEWERAGE RETICULATION

## SEWER NOTES

- 1. ALL LEVELS ARE IN METRES TO AUSTRALIAN HEIGHT DATUM (A.H.D.)
- CO-ORDINATES FOR SETTING OUT, WHERE SHOWN, ARE TO M.G.A.
- WORKS MUST BE CONSTRUCTED ACCORDING TO THE RELEVANT COLIBAN WATER SPECIFICATIONS AND STANDARD DRAWINGS. ALL MATERIALS ARE TO BE IN ACCORDANCE WITH COLIBAN WATER'S PREFERRED EQUIPMENT MANUFACTURERS LIST.
- CHAINAGES WHERE SHOWN ON DETAIL PLANS ARE DISCONTINUOUS AT MAINTENANCE
- CHAINAGES SHOWN ON LONGITUDINAL PLANS ARE CONTINUOUS.
- 6. PIPE MATERIAL, UNLESS SHOWN OTHERWISE.

PIPE TYPI	E PIPE CLASS	AUSTRALIAN STANDARD	LOCATION
P.V.C.	SN6 OR SN10	A.S. 1260	100MM DIA PROP. BRANCHES
P.V.C.	SN8	A.S. 1260	150MM DIA RETIC. SEWERS

NOTE: SEWERPRO AND UPVC PIPE IS NOT ACCEPTABLE TO COLIBAN WATER.

ACCESS CHAMBERS

A. ACCESS CHAMBER COVERS SHALL BE LEVEL WITH AND SHALL CONFORM TO SLOPE AND CONSTRUCTION LEVELS INCLUDING COVER GRADES BASED ON THE ROAD AND DRAINAGE PLANS. ALL SEWER COVERS ARE TO BE CONSTRUCTED TO THESE LEVELS. MAXIMUM SLOPE FOR CLASS C OR D COVERS TO BE 1 IN 10. MAXIMUM SLOPE FOR CLASS A OR B COVERS TO BE 1 IN 4. ACCESS CHAMBERS AND INSPECTION SHAFTS IN ROAD RESERVES AND R.O.W.'S CONSTRUCTED

PRIOR TO THE CONSTRUCTION OF FOOTPATHS SHALL BE PROVIDED WITH A TEMPORARY COVER. THE PLACING OF THE FINAL COVER SHALL NOT BE CARRIED OUT UNTIL THE CONCRETE FOOTPATH HAS BEEN CONSTRUCTED.

B. ALL ACCESS CHAMBERS TO BE 1070MM DIAMETER UNLESS OTHERWISE SHOWN.

EARTHWORKS

IN AREAS SUBJECT TO EARTHWORKS, THE CONSTRUCTION OF SEWERS MUST NOT COMMENCE UNTIL THE EARTHWORKS HAVE BEEN COMPLETED OR THE SUPERINTENDENT GIVES WRITTEN APPROVAL TO COMMENCE. SUCH APPROVAL WOULD NOT BE GIVEN UNLESS THE CONTRACTOR CAN DEMONSTRATE THAT THE SEWER WOULD BE SATISFACTORILY PROTECTED AGAINST DAMAGE FROM CONSTRUCTION LOADS.

WHERE CLEAR COVER LESS THAN 600MM, TYPE F2C BEDDING AND COVERING SHALL BE PLACED AROUND SEWERS. UNDER ROAD PAVEMENTS WHERE THE CLEARANCE BETWEEN THE TOP AND BOTTOM OF BOXING AND TOP OF SEWER IS LESS THAN 900MM, TYPE F2C BEDDING AND COVERING SHALL BE PLACED AROUND SEWERS.

- THE CONTRACT IS IN ACCORDANCE WITH AS2124-1992. IN ACCORDANCE WITH CLAUSE 15 OF. AS2124-1992. THE CONTRACTOR MUST ENSURE THE SAFETY OF THE CONTRACTORS EMPLOYEES AND ALL OTHER PEOPLE WHO ARE ON OR ADJACENT THE SITE.
- 10. COLIBAN WATER MUST BE NOTIFIED BY THE CONTRACTOR FIVE WORKING DAYS PRIOR TO COMMENCING WORKS ON EXISTING SEWER.
- 11. CONNECTION TO LIVE SEWER: CONFINED SPACE ENTRY MUST BE IN ACCORDANCE WITH BOTH COLIBAN WATER AND OH&S REQUIREMENTS. CONTRACTOR MUST NOT ENTER A CONFINED SPACE UNTIL ALL REQUIRED INFORMATION HAS BEEN SUBMITTED TO COLIBAN WATER.
- 12. PROPERTY BRANCH FITTINGS MUST BE LOCATED AT LEAST 0.5M WITHIN PROPERTY BEING SERVICED, AND CLEAR OF ANY OBSTRUCTIONS. PROPERTY CONNECTION POINT JUMP UPS ARE TO BE FINISHED AT SURFACE LEVEL AS PER COLIBAN WATER ANNEXURE TO WSAA02-2002-2.3
- 13. 7 CLEAR DAYS NOTICE PRIOR TO COMMENCEMENT OF THE WORKS MUST BE GIVEN TO THE SUPERINTENDENT.

14. SERVICE CONNECTIONS

ALL NEW SERVICE CONNECTIONS MUST BE IN ACCORDANCE WITH THE REQUIREMENTS OF COLIBAN WATERS SPECIFICATION OF WORKS FOR CONSTRUCTION OF RETICULATION SEWERS AND ASSOCIATED STRUCTURES, AS3500 AND THE SEWERAGE STANDARD DRAWINGS.

- 15. BLASTING NO BLASTING IS PERMITTED.

ALL NEW SEWERS MUST BE PRESSURE TESTED. WHERE THE CONTRACTOR DOES NOT HAVE A QUALITY ASSURANCE SYSTEM IN PLACE, ALL PIPES MUST BE INSPECTED BY THE SUPERVISING ENGINEER.

17. ENVIRONMENTAL REQUIREMENTS

A. ALL TREES MUST BE PRESERVED AND PROTECTED AT ALL TIMES.

- B. TREES MARKED X ON THE DESIGN PLANS MAY BE REMOVED.
- 18. WI N25 GRADE CONCRETE GP TYPE CEMENT MUST BE USED IN ALL CONSTRUCTION, UNLESS OTHERWISE NOTED IN COLIBAN WATERS SEWER DESIGN

A. THE CONTRACTOR SHALL BE RESPONSIBLE FOR VERIFICATION OF THE HORIZONTAL ALIGNMENT AND FOR OFFSETTING PEGS DURING CONSTRUCTION

B. SETOUT AND VERIFICATION OF LEVELS SHALL REMAIN THE RESPONSIBILITY OF THE CONTRACTOR.

- THIS DESIGN COMPLIES WITH COLIBAN WATER STANDARDS AND THE SUPPLY OFFER SME xxxxx DATED xx xxxx xxxx
- 21. THE CONTRACTOR MUST LOCATE ALL EXISTING SERVICES PRIOR TO THE COMMENCEMENT OF WORKS.
- 22. THE LEVEL OF ALL EXISTING OUTFALL SEWERS MUST BE CONFIRMED BY THE CONTRACTOR PRIOR TO WORKS COMMENCING
- 23. CLASS 3 FCR BACKFILL MUST BE USED WHERE SEWER MAINS CROSS ROAD PAVEMENT, FOOTPATHS OR DEFINED DRIVEWAYS.
- 24. PROPERTY CONNECTION POINT JUMP UPS ARE TO BE FINISHED AT SURFACE LEVEL WITH A CONCRETE SURROUND AND COVER AS PER COLIBAN WATER'S
- 25. THE CONTRACTOR MUST ADHERE TO THE CODE OF PRACTICE FOR 'SAFETY PRECAUTIONS IN TRENCHING OPERATIONS" UNDER THE "OCCUPATIONAL HEALTH & SAFETY ACT 2004"
- 26. GATIC STYLE STEEL LIDS ARE TO BE USED ON MANHOLES AS PER THE CLASS SPECIFIED. CAST IRON CONCRETE INFILL STYLE COVERS ARE NOT ACCEPTABLE.
- 27. MANHOLE BENCHING AND CHANNELS TO BE FINISHED WITH A METAL FLOAT. BROOM FINISH IS NOT ACCEPTABLE.
- CONTRACTOR TO DETERMINE WHETHER A SOCKET JOINT OF COUPLING (RRJ) AND A SHORT "ROCKER" PIPE IS REQUIRED TO BE INSTALLED TO PROVIDE FLEXIBILITY NECESSARY TO ACCOMMODATE DIFFERENTIAL SETTLEMENT BETWEEN THE MH BASE AND THE SEWER. SOLVENT CEMENT JOINT SHOULD NOT BE USED IF MH FOUNDATION HAS A BEARING PRESSURE LESS THAN 100KPA.


# SERVICE LOCATION TABLE

ROAD NAME		POTABLE WATER		GAS		BN ECOM)	ELECTRICITY				
	SIDE	OFFSET	SIDE	OFFSET	SIDE	OFFSET	POLE		U/G CABLE		
	SIDE	UFFSET					SIDE	OFFSET	SIDE	OFFSET	
KENNEWELL STREET	W	3.4 (EX)	E	4.0 (EX)	W	1.5 (EX)	Е	3.0 (EX)	E	4.5	
SCOTT STREET	N	5.0 (EX)	N	3.6 (EX)	N	2.6 (EX)	-	-	-	-	
ST KILLIAN STREET (CH 7.00 – 28.00)	Е	7.75	E	Varies	Е	2.7	W	4.0 (EX)	E	2.2	
ST KILLIAN STREET (CH 47.00 - 100.00)	E	3.95	E	4.4	E	2.7	W	4.0 (EX)	E	2.2	
ST KILLIAN STREET (CH 100.00 - 130.16)	Е	Varies	E	Varies	E	Varies	-	-	E	Varies	
ST KILLIAN STREET (CH 130.16 - 194.03)		2.5	E	2.95	E	1.75 (EX)	ı	-	E	1.0	

1. TELECOMMUNICATIONS AND ELECTRICITY CABLES TO BE CONSTRUCTED IN A COMMON TRENCH IN ACCORDANCE WITH ELECTRICITY

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- AUTHORITY STANDARD DRG's.
- GAS AND WATER MAINS TO BE CONSTRUCTED IN A COMMON TRENCH.
- × = OFFSET FROM BACK OF KERB
- (EX) = SERVICE IS EXISTING 5. (Var) = SERVICE OFFSET CAN VARY IN SECTIONS

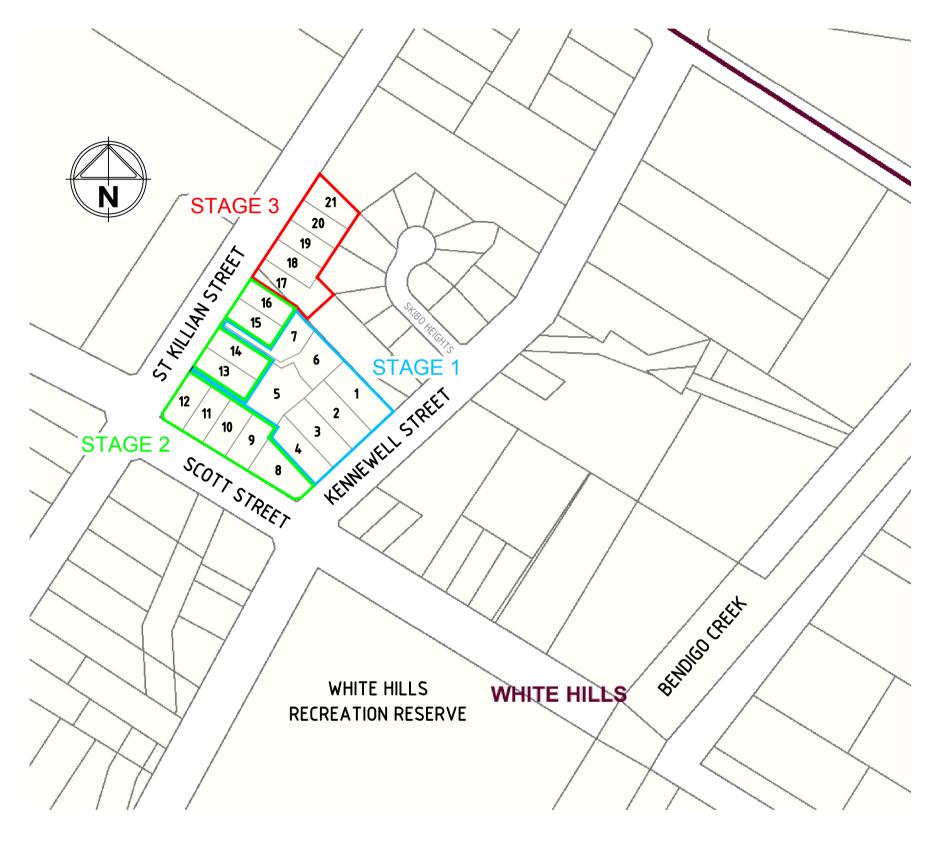

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# WARNING

BEWARE OF UNDERGROUND/OVERHEAD SERVICES THE LOCATION OF SERVICES ARE APPROXIMATE ONLY AND THEIR EXACT POSITION SHOULD BE PROVEN ON SITE. NO GUARANTEE IS GIVEN THAT ALL EXISTING SERVICES ARE SHOWN.SPECIAL CONSIDERATION SHOULD BE GIVEN TO CONSTRUCTION PROCEDURES UNDER OVERHEAD ELECTRICITY TRANSMISSION LINES.

											DESIGNED	JF	PROJECT NUMBER	SME 18151	
											DRAWN	JF	MELWAY REFERENCE	604 B9	JL
Α	INITIAL PREDESIGN PLANS		21-05-18	JF							CHECKED	DI	ALITHODISED	BI	
REV	REV DESCRIPTION		DATE	APPROVED	REV	DE	SCRIPTION	DA <sup>-</sup>	TE	APPROVED	CHECKED	BI	AUTHORISED	DATE: 21-05-18	
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LEJ INVESTMENTS SPIIRE 16 Bridge Street Bendigo Victoria 3550 Australia T 61 3 5448 2500

Coliban WATER SEWER RETIC GENERAL NOTES

COLIBAN WATER CITY OF GREATER BENDIGO THE PERCH STAGE 3

SHEET: 1 OF 3 DRAWING No.: 302102CS100

SCALE:NTS

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